CERTIFICATE OF APPROPRIATENESS APPLICATION FORM



PLANNING & DEVELOPMENT DEPARTMENT

	OTHWELL Str	,		
Historic District / Landmark		HCAD #		
Subdivision		Lot	Block	
DESIGNATION TYPE		PROPOSED ACTION		
🗙 Landmark	Contributing	Alteration or Addition	Relocation	A
Protected Landmark	Noncontributing	Restoration	🕅 Demolition 🔹	f Non Historic Portion
Archaeological Site	🔲 Vacant	New Construction	Excavation	Portion
DOCUMENTS				
Application checklist for	each proposed action and all	applicable documentation listed	within are attached	
OWNER,		APPLICANT (if other the	an owner)	
Name CERZ PRO	perties, L.P.	Name		
Name CERZ PRO Company C/O Clay	CRAWFORD	Company		
Mailing Address /200	ROTHWELL St.	Mailing Address		
Houston	1 Tx 77002			

Phone

Email

Date

Signature

ACKNOWLEDGEMENT OF RESPONSIBILITY

223-3333

713-

Phone

Email

Date

Signature

2

Requirements: A complete application includes all applicable information requested on checklists to provide a complete and accurate description of existing and proposed conditions. Preliminary review meeting or site visit with staff may be necessary to process the application. Owner contact information and signature is required. Late or incomplete applications will not be considered.

Deed Restrictions: You have verified that the work does not violate applicable deed restrictions.

Public Records: If attached materials are protected by copyright law, you grant the City of Houston, its officers, agencies, departments, and employees, non-exclusive rights to reproduce, distribute and publish copyrighted materials before the Houston Archaeological and Historical Commission, the Planning Commission, City Council, and other City of Houston commissions, agencies, and departments, on a City of Houston website, or other public forum for the purposes of application for a Certificate of Appropriateness or building permit, and other educational and not for profit purposes. You hereby represent that you possess the requisite permission or rights being conveyed here to the City.

Compliance: If granted, you agree to comply with all conditions of the COA. Revisions to approved work require staff review and may require a new application and HAHC approval. Failure to comply with the COA may result in project delays, fines or other penalties.

Application received: ___/ ___ Application complete: ___/ ___/

Planner: _____

Certificate of Appropriateness February 27, 2018 1200 Rothwell Street a/k/a 1200 Nance Houston, Texas 77002

Property Description

The building was built in 1881. It is known as Henry Henke Fifth Ward Grocery Store. The building is located at 1200 Rothwell, Houston, Texas 77002 which is also known as 1200 Nance.

Background:

When we acquired the property in 2004, the 1881 building was an empty brick shell. It had no mechanical, electrical or plumbing. There were no interior walls or other interior improvements. We sought and received a COA to renovate the interiors of the 1881 Building and to build an addition along the entire south side of the existing 1881 Building. The addition provided space to locate the mechanical, electrical and plumbing services. The new addition provided needed space for a breakroom area and restrooms on the first floor. It also provided the space to construct a stairwell to provide access the second floor of the 1881 Building. (For clarity throughout this Application, the original structure will be referenced as the "1881 Building." The structure added in 2004 along the south side of the 1881 Building will be referenced as the "2004 Addition.")

Unfortunately, after a huge expenditure of time and money to revitalize this property, we learned that the historic warehouse district, and our building in particular, is prone to flooding even during minor rainfall events. We have enclosed a photograph of our building following a modest 4.5 inch rainfall. The photos shows how water quickly pools in the street, comes up over the curb and presses against the first floor exterior of the 1881 Building and the 2004 Addition.

We have had four separate water incursions into the building in the past two years. After each of these flooding events, we have considered every conceivable solution to this recurring problem. We previously sought and received a COA to purchase and install custom made, water-resistant doors. Unfortunately, the flood-resistant doors failed to prevent a water incursion during a rain event on January 18, 2017.

We have also worked closely with City of Houston officials during the few past years. Unfortunately, the City has concluded that nothing can be done to prevent future flooding of our building except a major capital improvement to increase the storm water capacity in the warehouse district. At this time, the City has no plans to undertake such a project.

In August 2017, Hurricane Harvey destroyed the first floor of the 1881 Building and the interior of first floor of the 2004 Addition. Hurricane Harvey has made it abundantly clear that simply rebuilding what

we have is no longer a viable option. To insure the long term survival of the building, a massive redesign of the property is required.

Over the past six months, our architecture team, in close collaboration with the staff of Historic Preservation, has formulated a plan to save the 1881 Building. As set forth in more detail in the drawings, the proposed plan makes no significant changes to the current exterior façade of the 1881 Building. The plan proposes to demolish the 2004 Addition and replace it with a new addition (located in the same position along the south side of the 1881 Building) which extends out over the current parking lot. The proposed new addition will provide additional space so that the kitchen, restrooms and conference room can be elevated. By elevating these essential services, the building will be more resilient and better able to continue normal operations during future floods.

Proposed Work

- 1. Demolish the 2004 addition
- 2. Elevate the interior of the first floor of the 1881 Building
- 3. Build a new addition along the south side of the 1881 Building which connects to the second floor of the 1881 structure. The new addition will extend over the current parking lot.

Current building materials conditions and originality of any materials proposed to be repaired or replaced.

There are no changes proposed to the currently visible exterior façade of the 1881 structure.

Proposed new materials description

See drawings submitted with the COA

Photographs

Elevations


See attached drawings submitted with the COA

Detailed photos of exterior elements subject to proposed work


See photos submitted with the COA


Historical photos as evidence for restoration work


Not applicable.

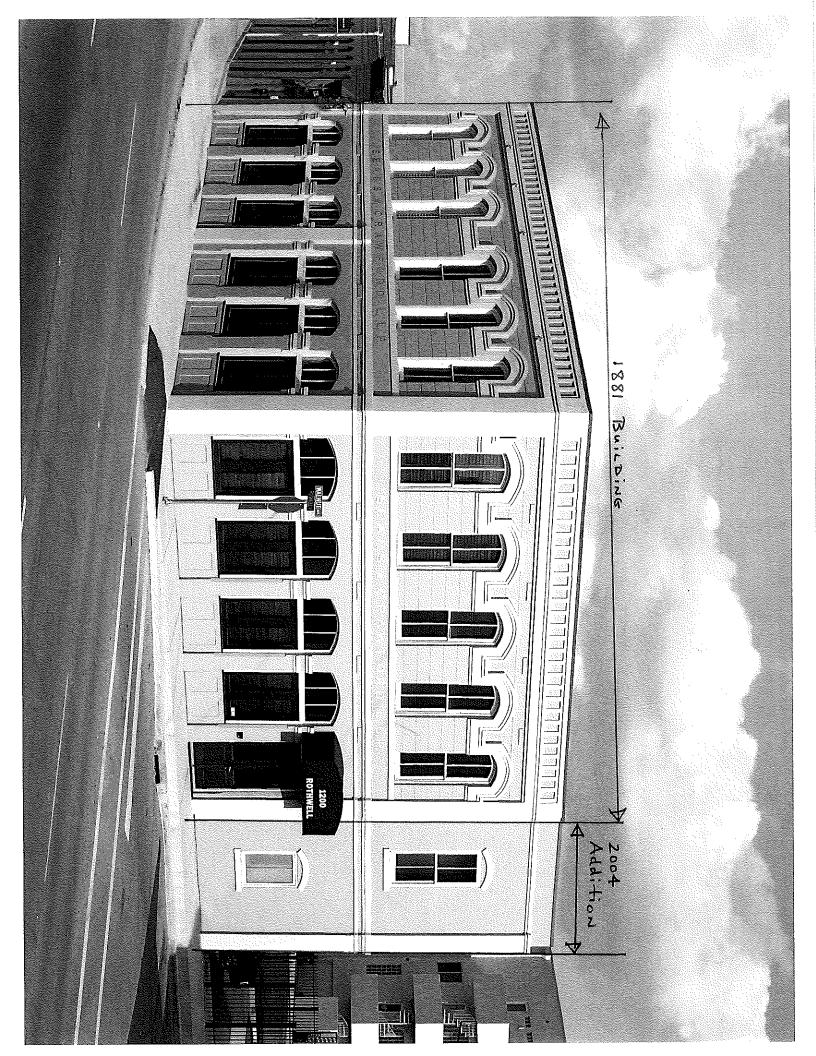



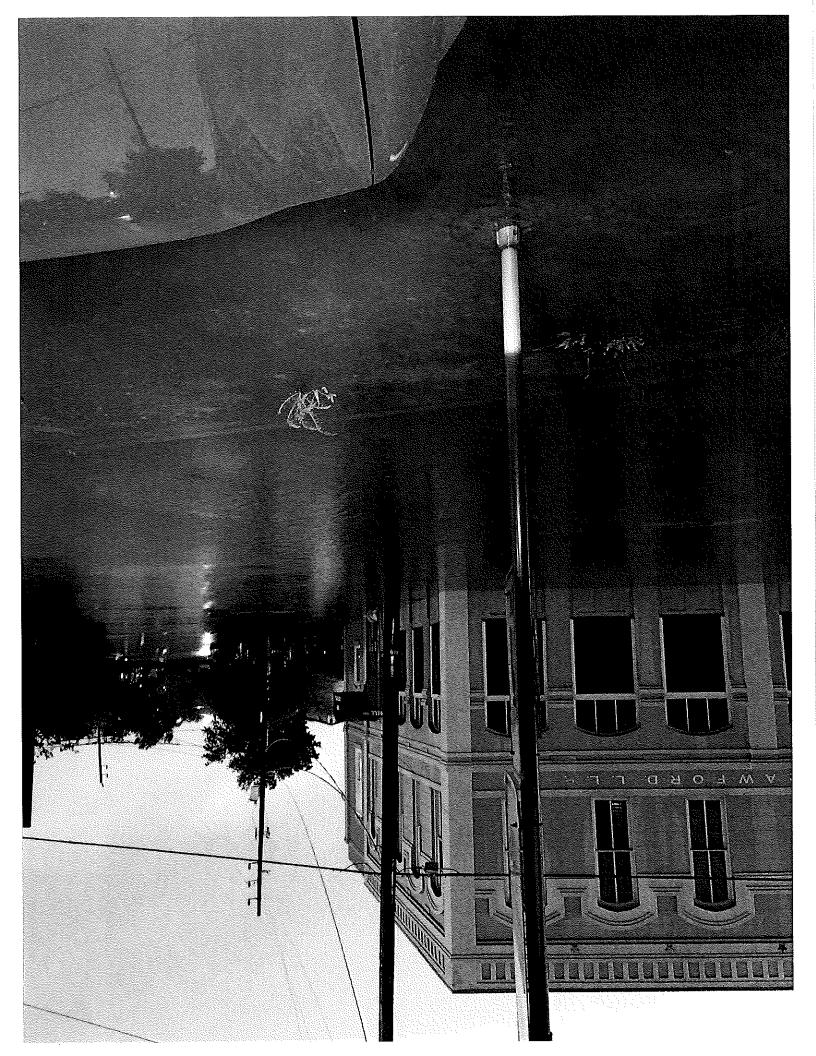

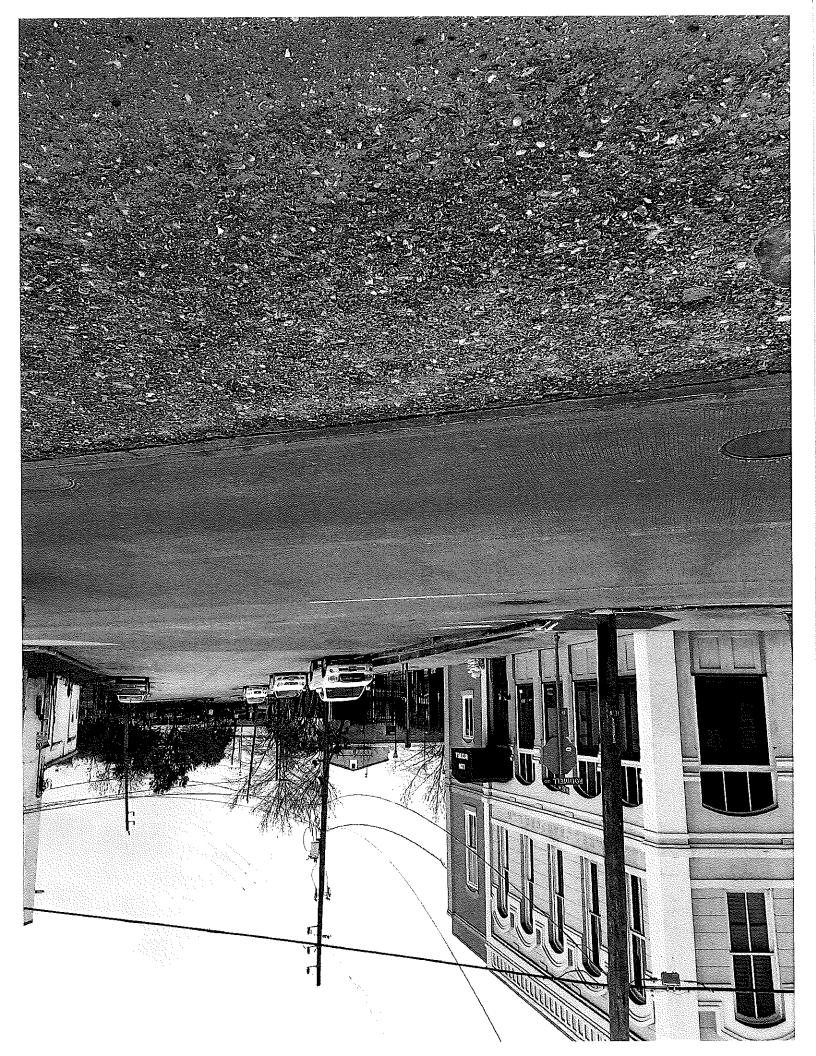


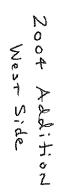





2004 Addi Hows South Side ••

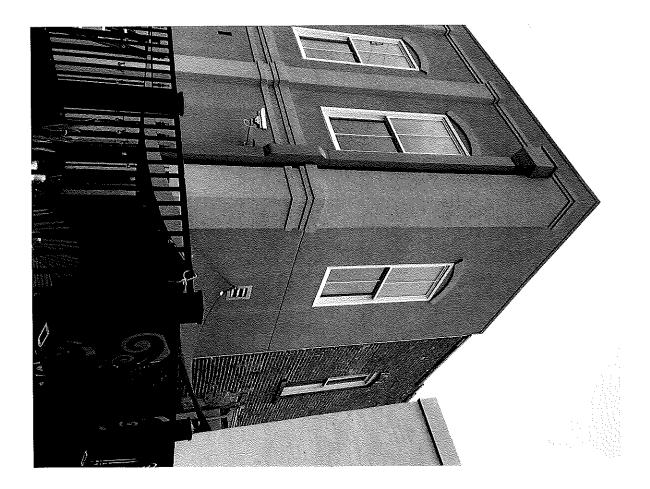

LocitibbA 4005 Sbig TEA3





drawing name

Title Sheet


drawing number

17.179.00

project number

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date ____issue name

1200 Rothwell Street Houston TX 77002
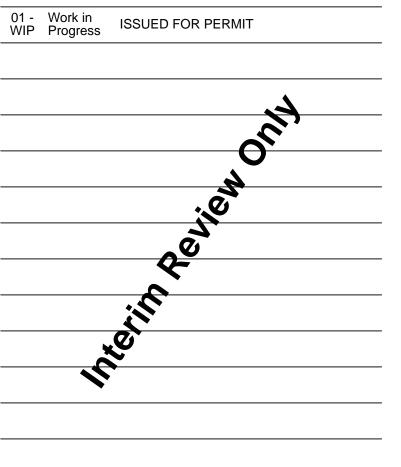
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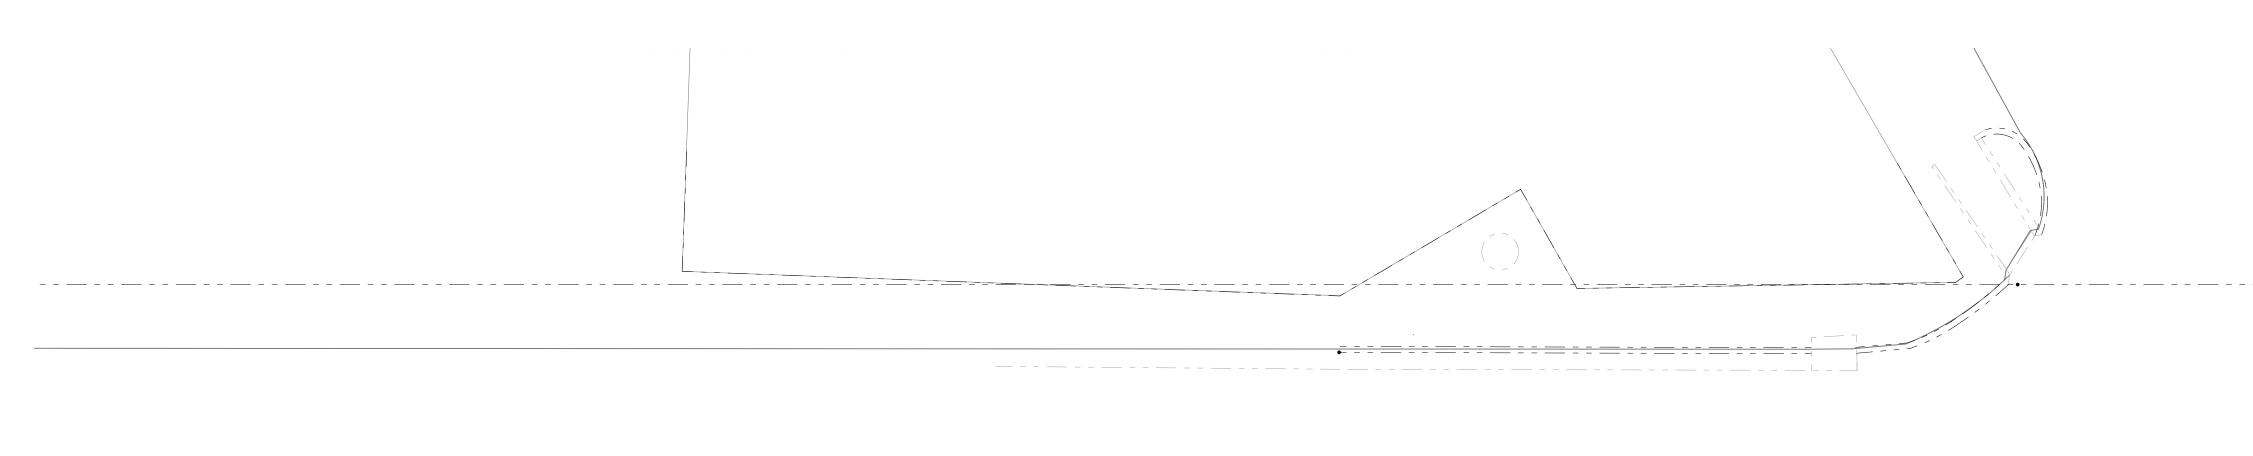
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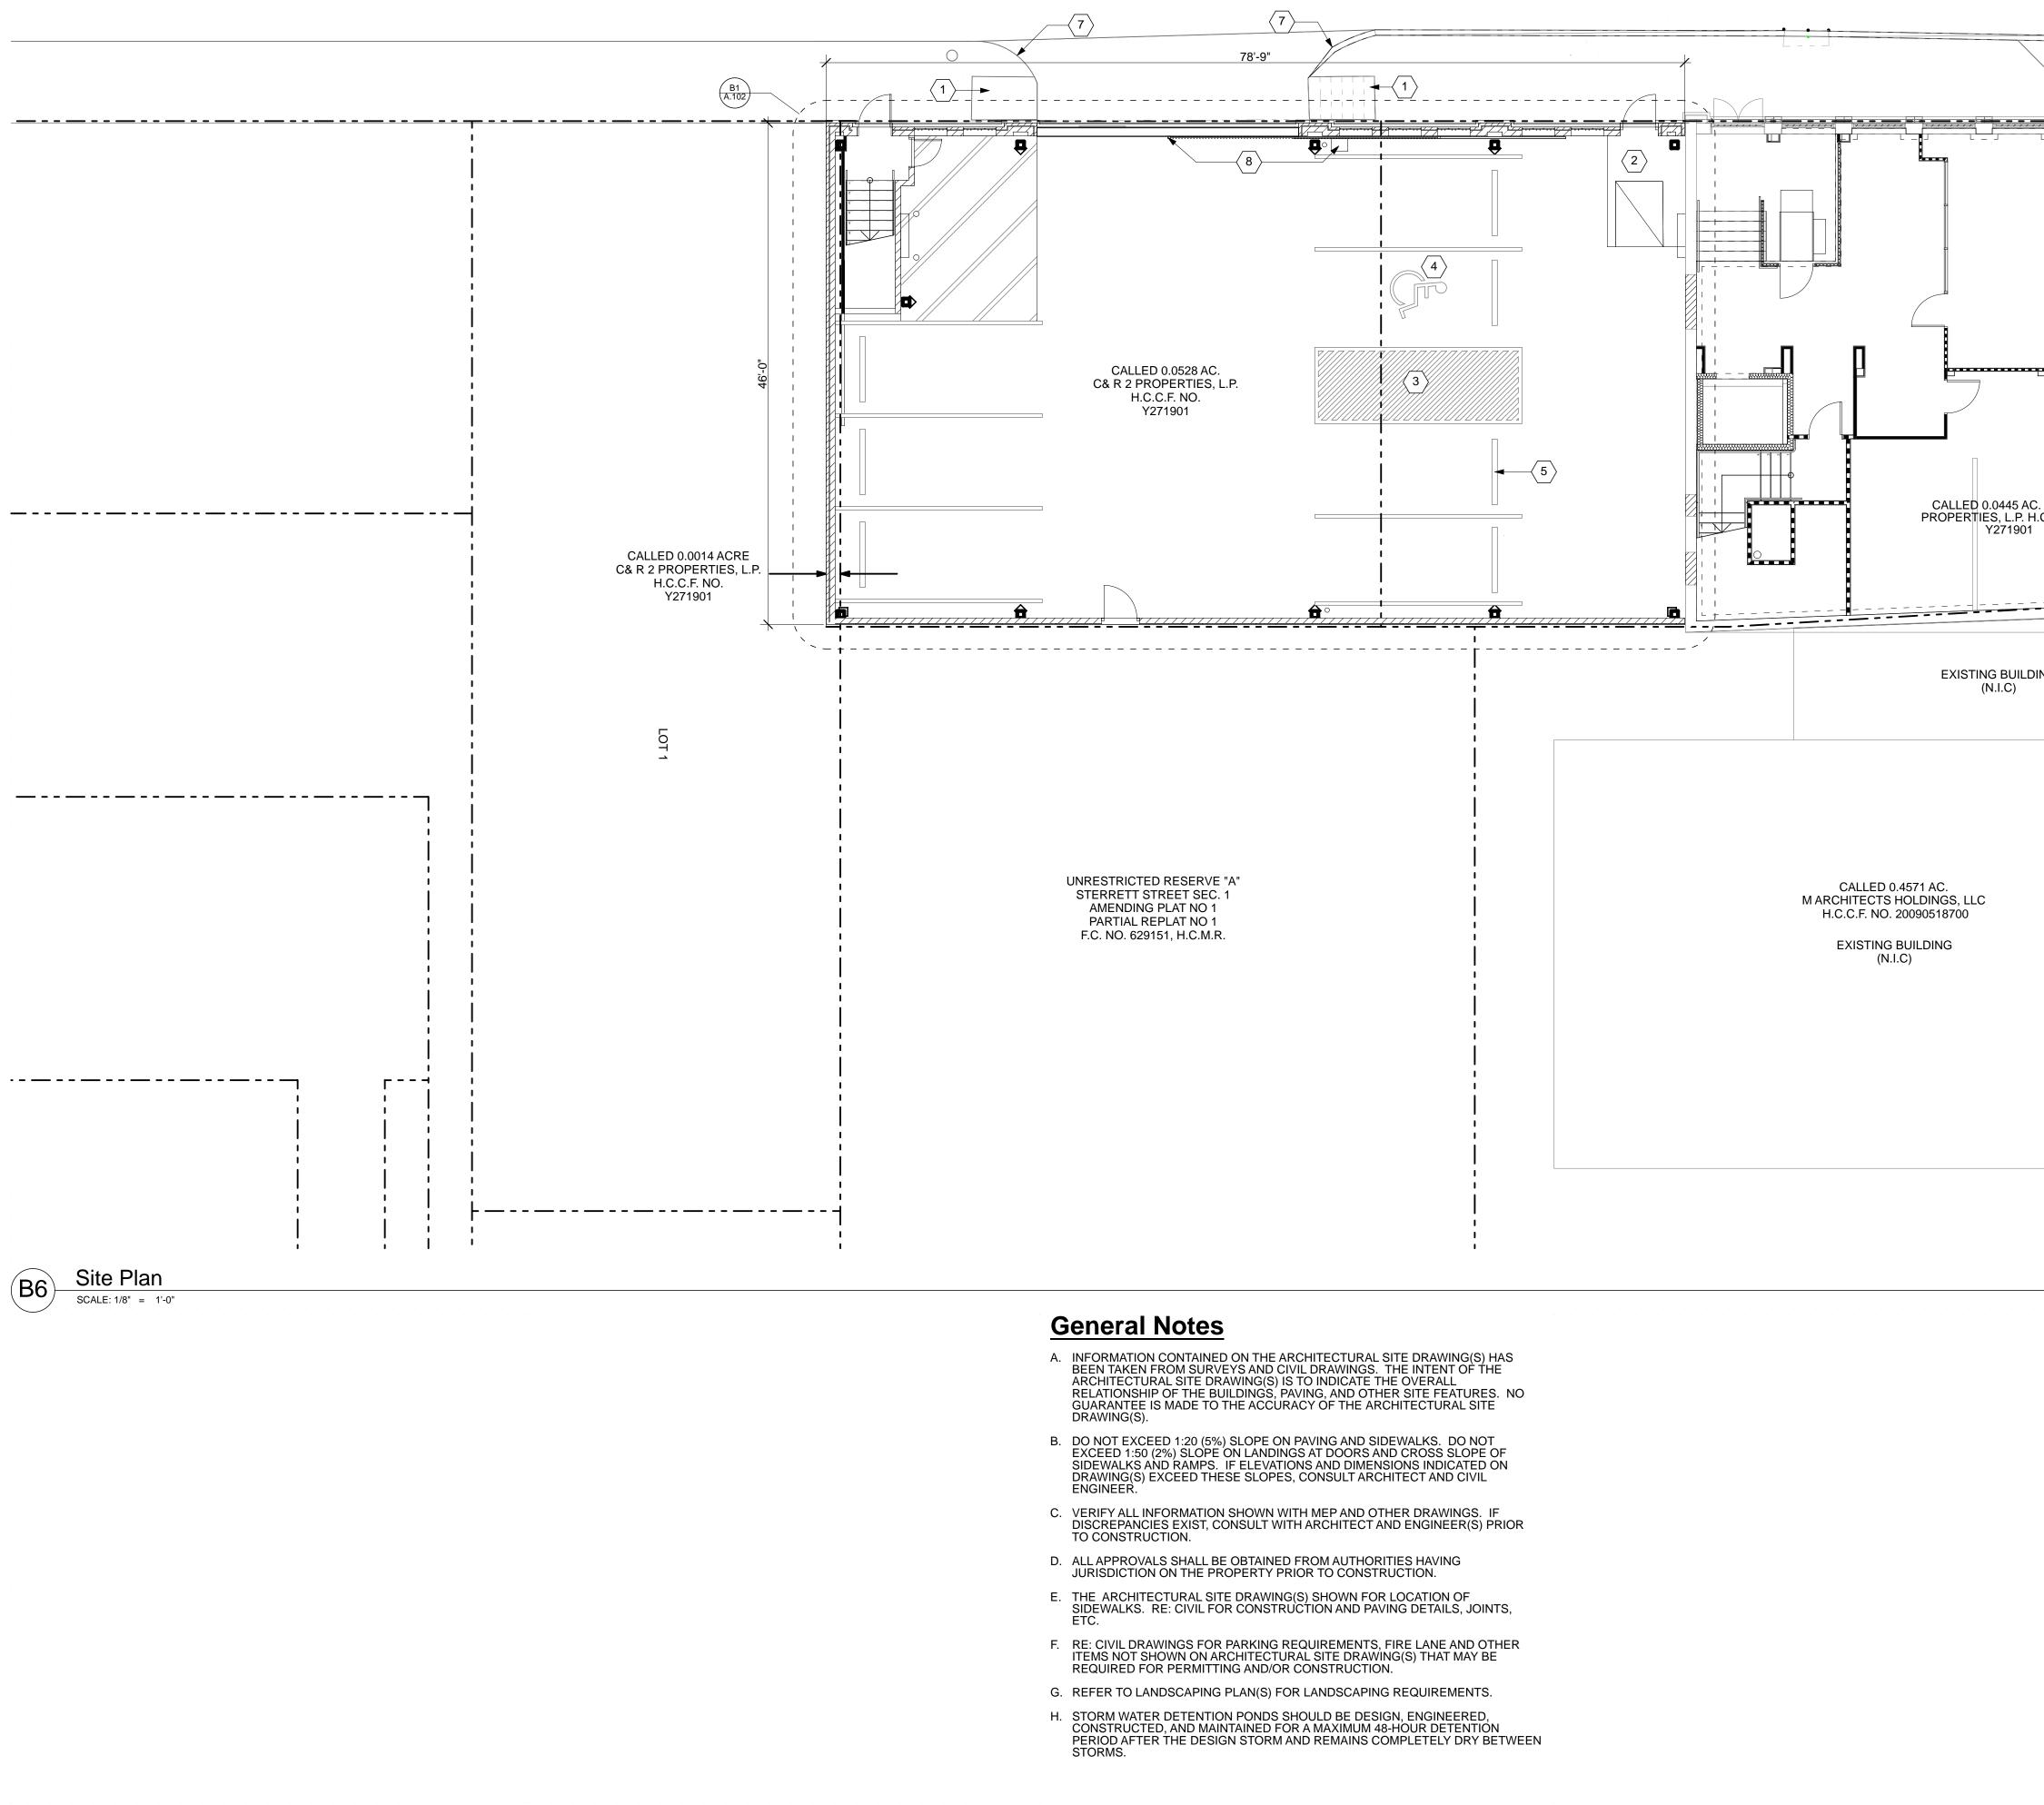
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project name

Name



WALNUT STREET 50' R.O.W.



	ROTHMELL STREET 60' R.O.W.	<image/> <image/> <image/> <image/> <image/> <image/> <section-header><section-header><section-header><section-header><section-header><section-header><section-header><text></text></section-header></section-header></section-header></section-header></section-header></section-header></section-header>
AC. C & R 2 P. H.C.C.F. NO.		<page-header><section-header><section-header><section-header><section-header><section-header><text></text></section-header></section-header></section-header></section-header></section-header></page-header>
NANCE STREET 50' R.O.W.		
 Sheet Notes 1. EXISTING SIDEWALKS TO REMAIN. 2. NEW RAMP AND SIDEWALK, EXTENT TO PROPERTY LINE. PROVIDE CONTROL JOINTS AND EXPANSION JOINTS PER CIVIL DRAWINGS. 3. PASSENGER LOADING ZONE. 4" WIDE WHITE STRIPING AT 12" O.C. AT 45° ANGLE. 4. VAN ACCESSIBLE PARKING SPACE. RE: #DrgID(ref)/#LayID(ref). 		 Interim Review Only Not for regulatory approval, permitting or construction. © Inventure Design Group. All rights reserved. No part of this doc may be reproduced or utilized in any form without prior written authorization of Inventure Design Group. project number
 CONCRETE WHEEL STOP TYP, RE: #DrgID(ref)/#LayID(ref). 6" Ø GALVANIZED STEEL BOLLARD TYP, PAINTED. RE: #DrgID(ref)/#LayID(ref). EXISTING CURB CUTS TO REMAIN. NEW MOTORIZED ACCESS GATE (OVERHEAD DOOR). DRAINAGE INLET, RE: CIVIL. 		17.179.00 drawing name Site Plan drawing number



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DESIGN







drawing number

Exterior Elevations

drawing name

17.179.00

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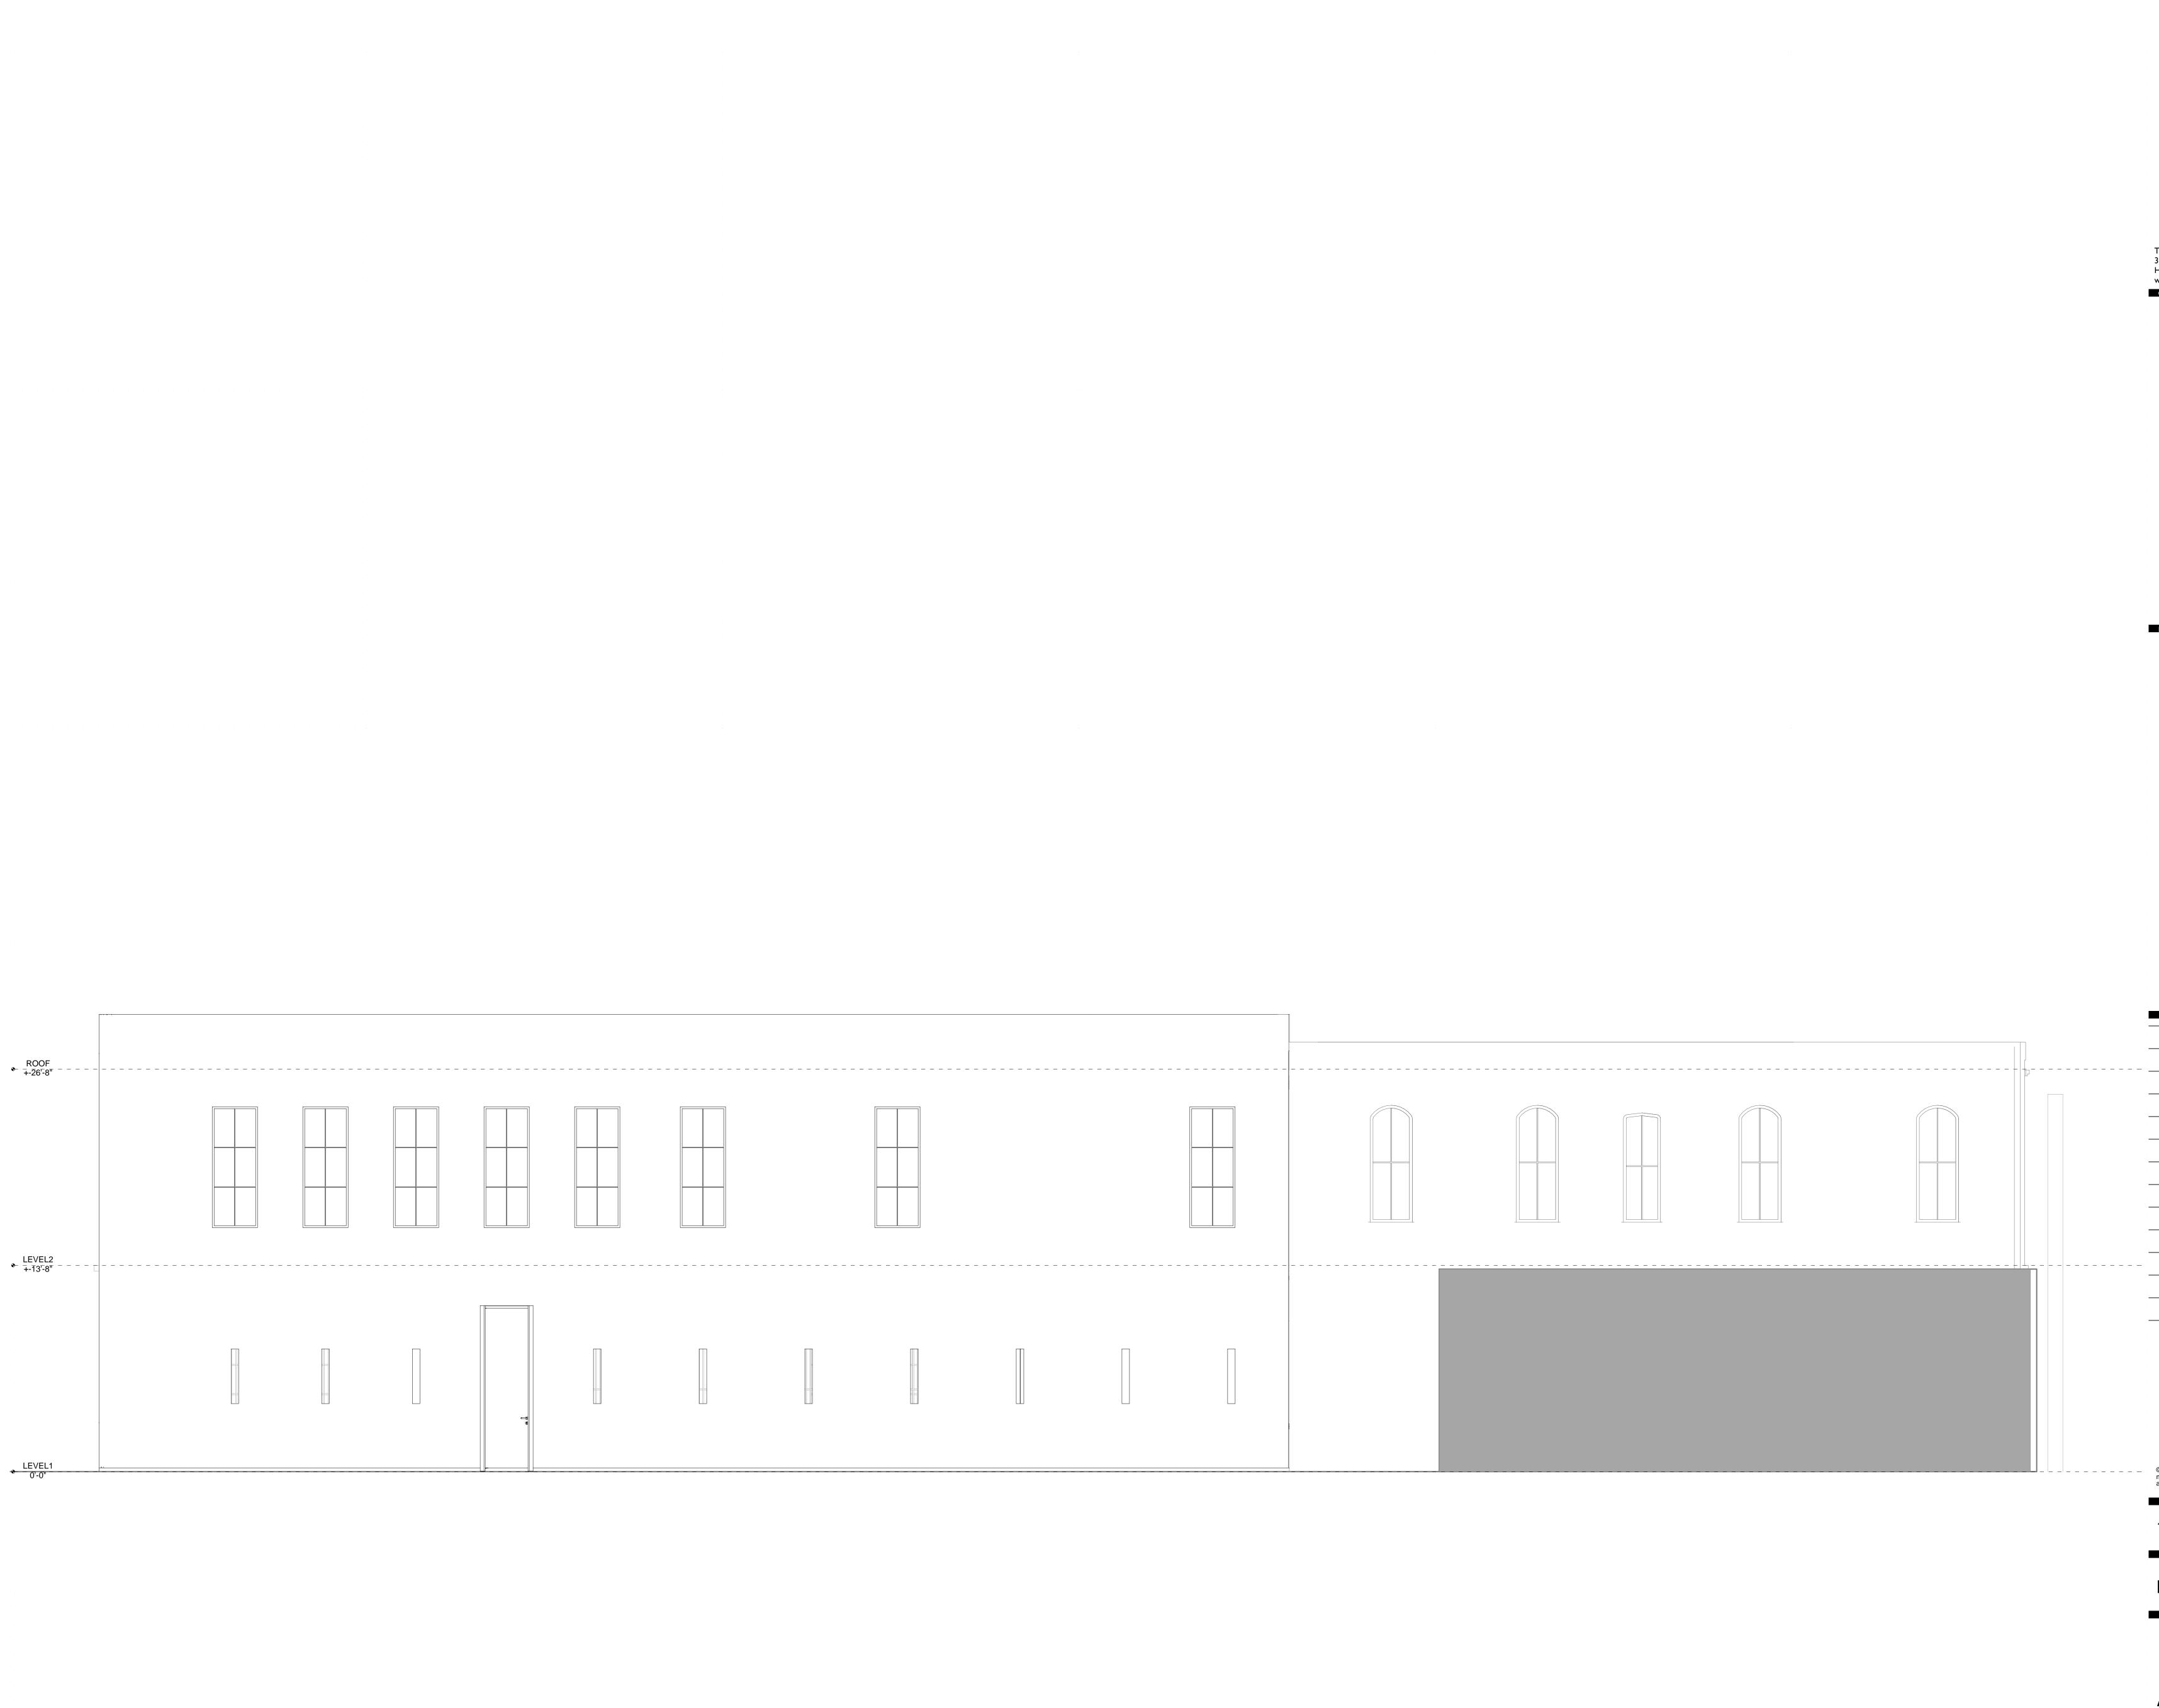
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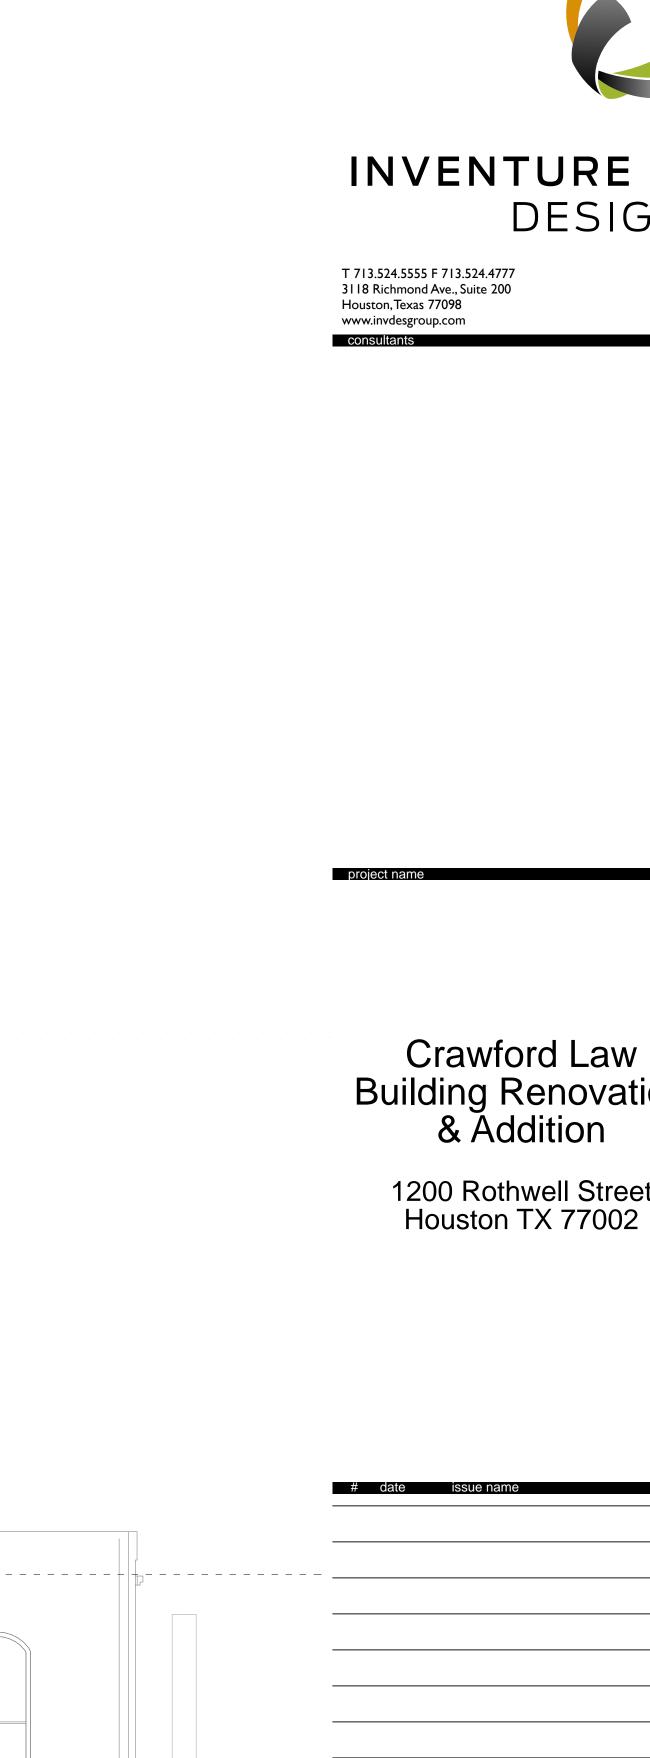
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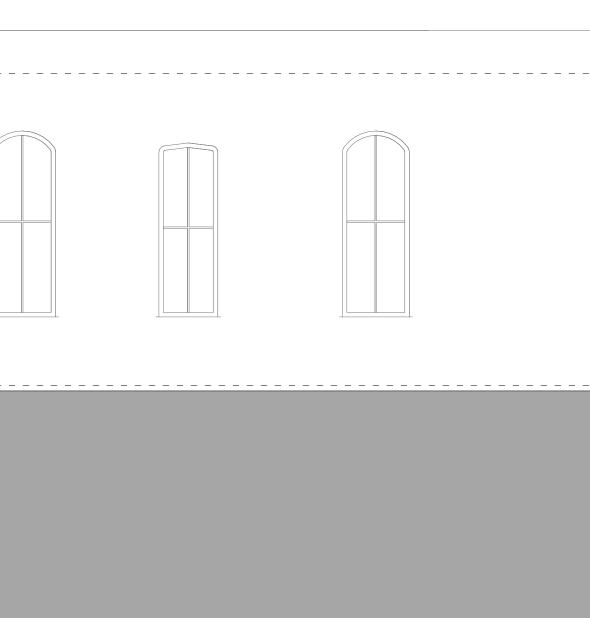
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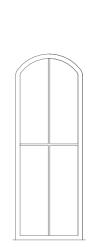


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drawing number

Exterior Elevations

drawing name

project number 17.179.00

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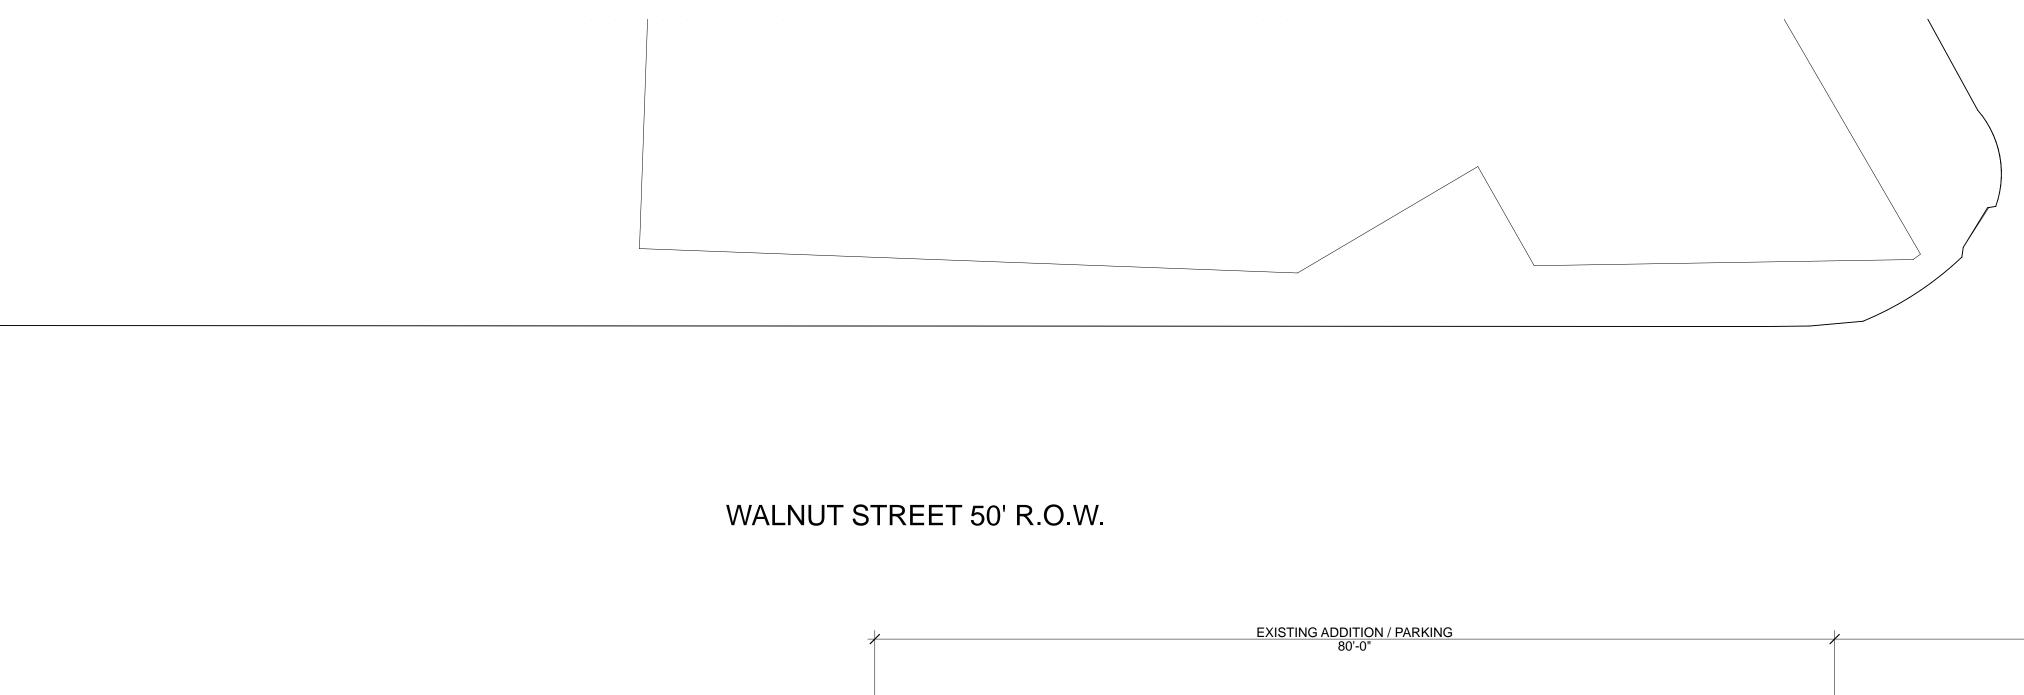
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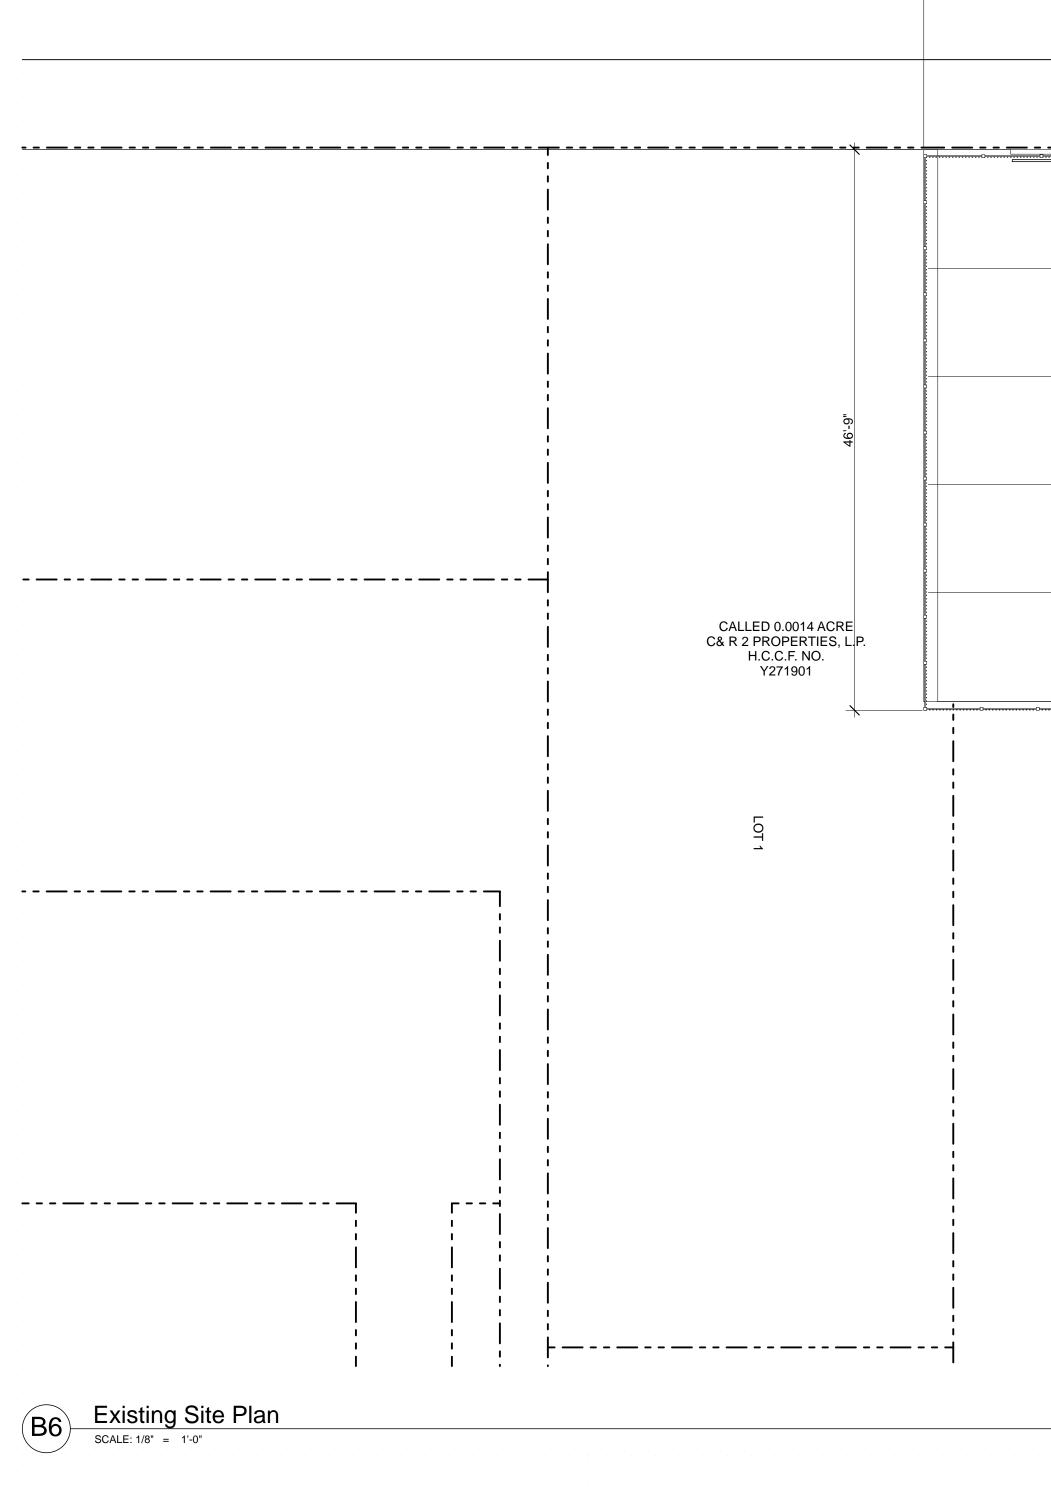
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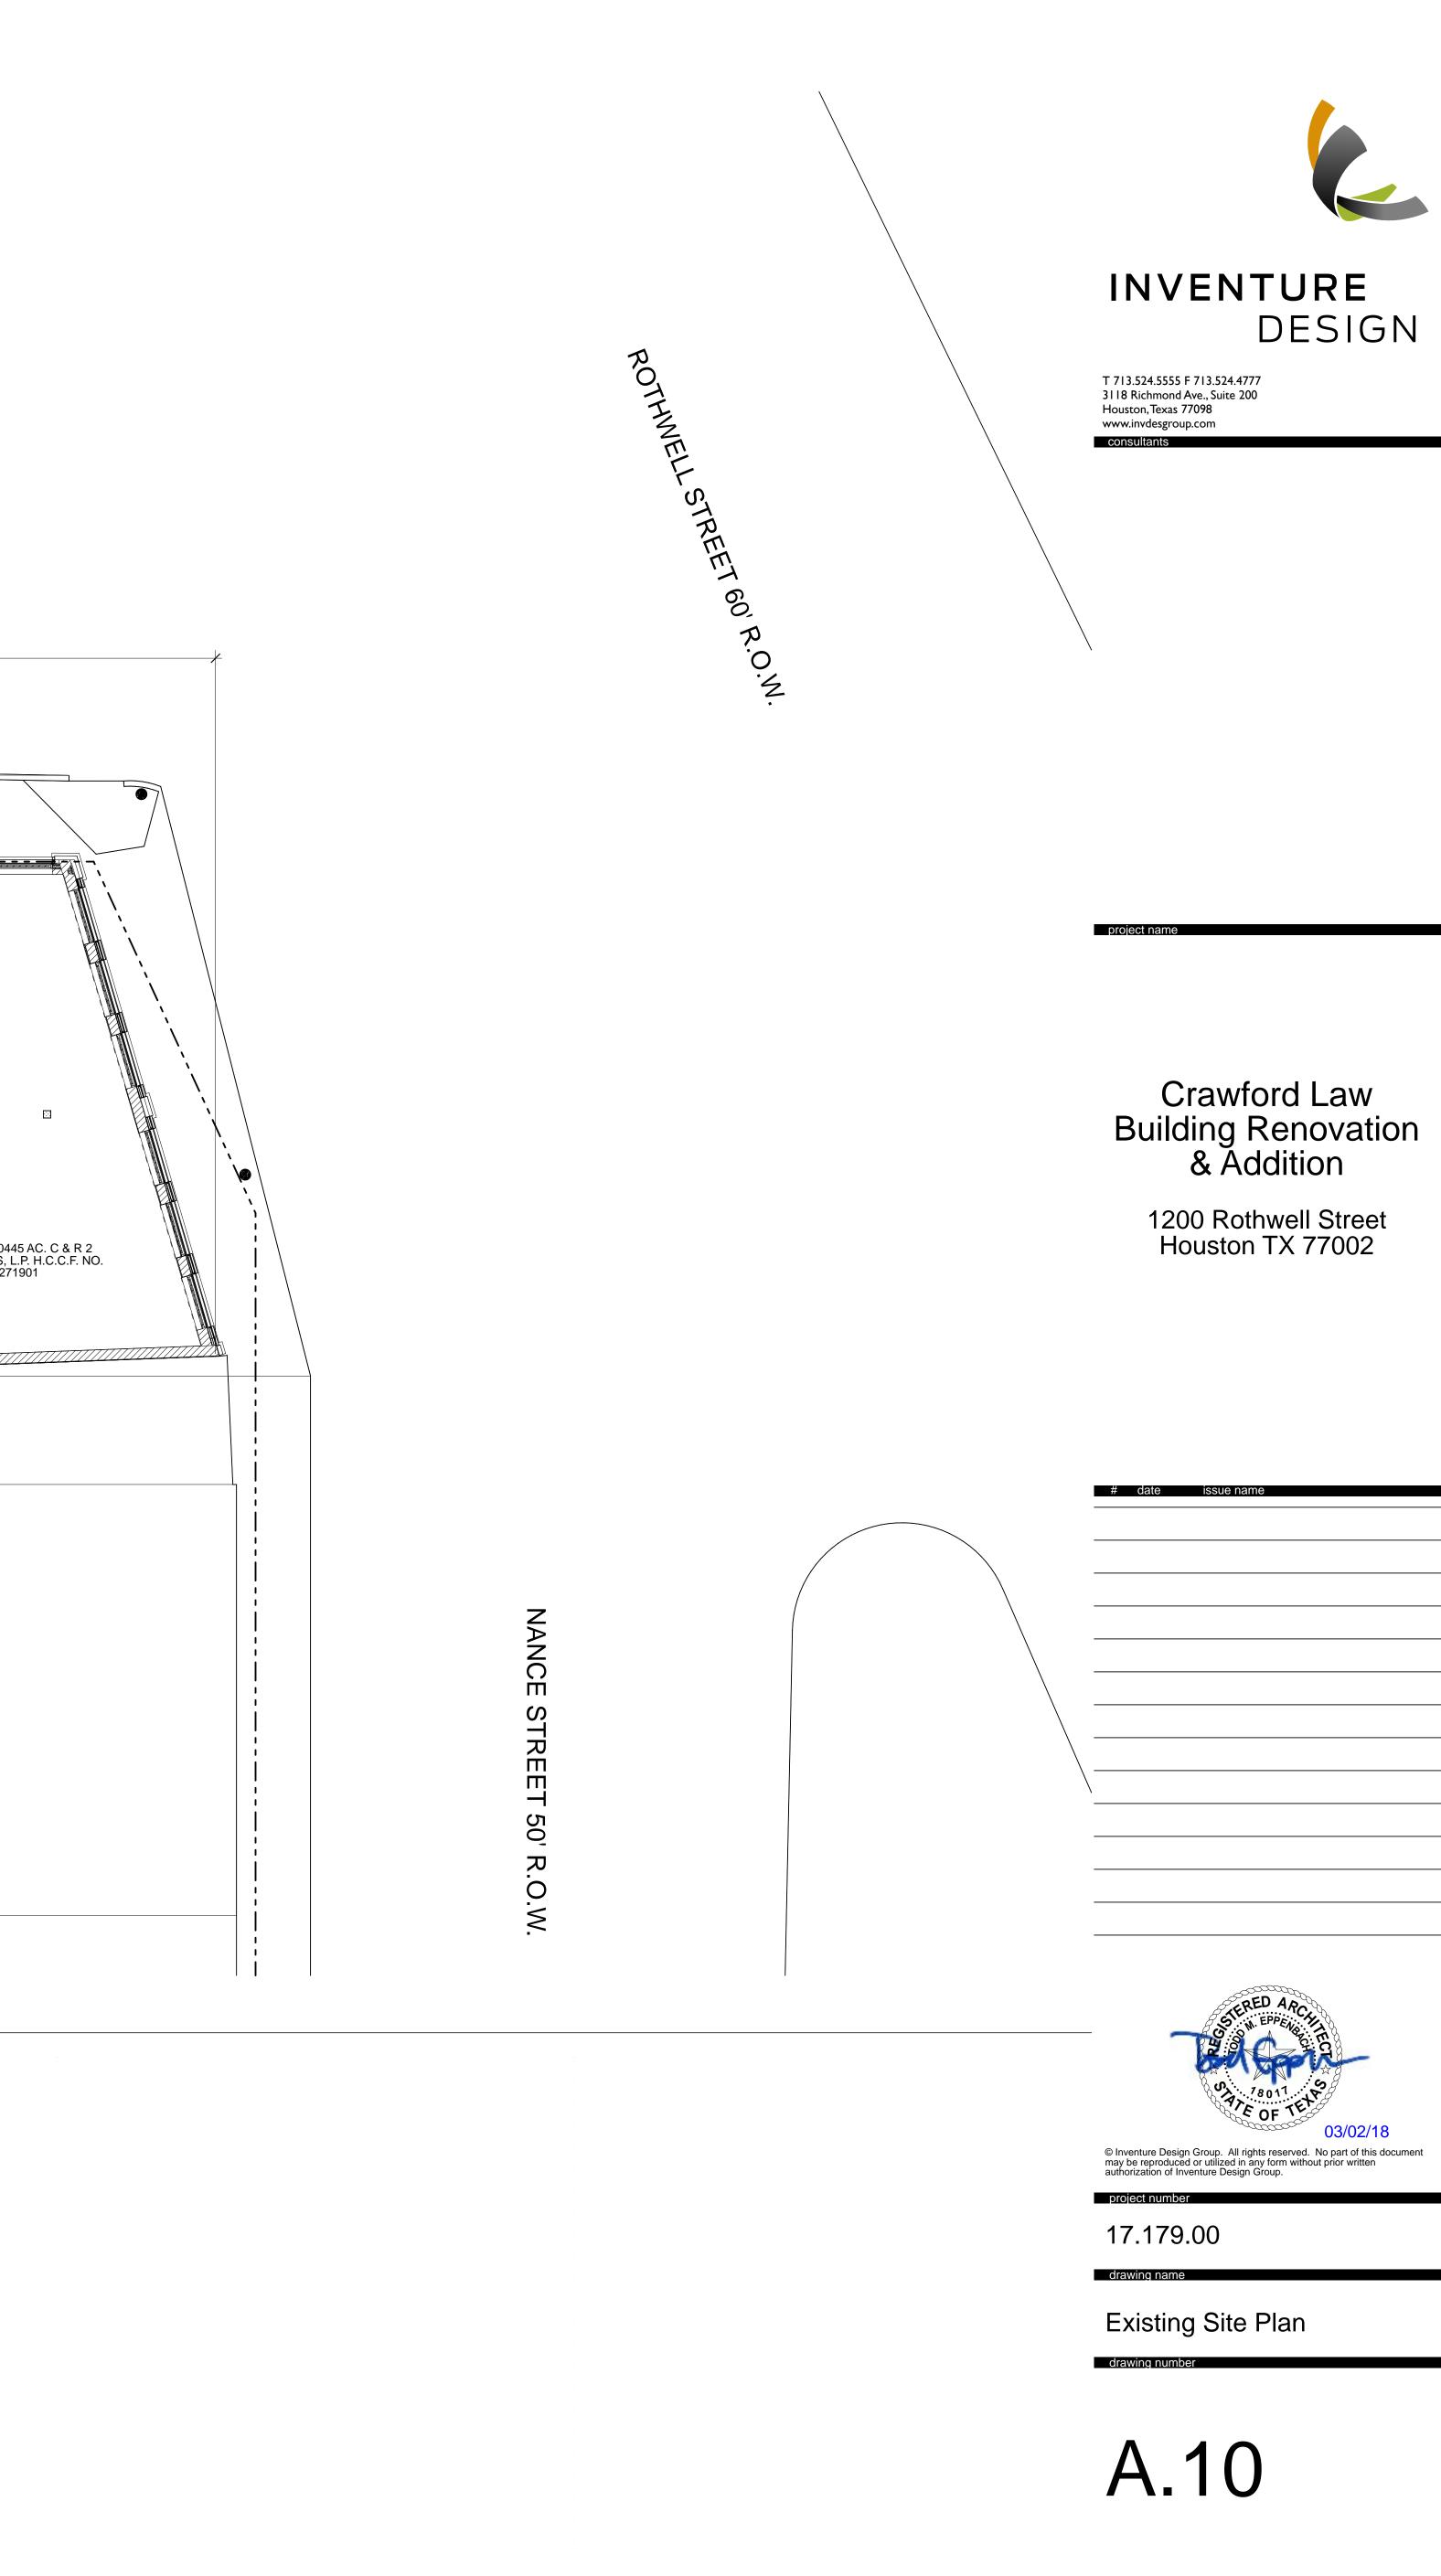



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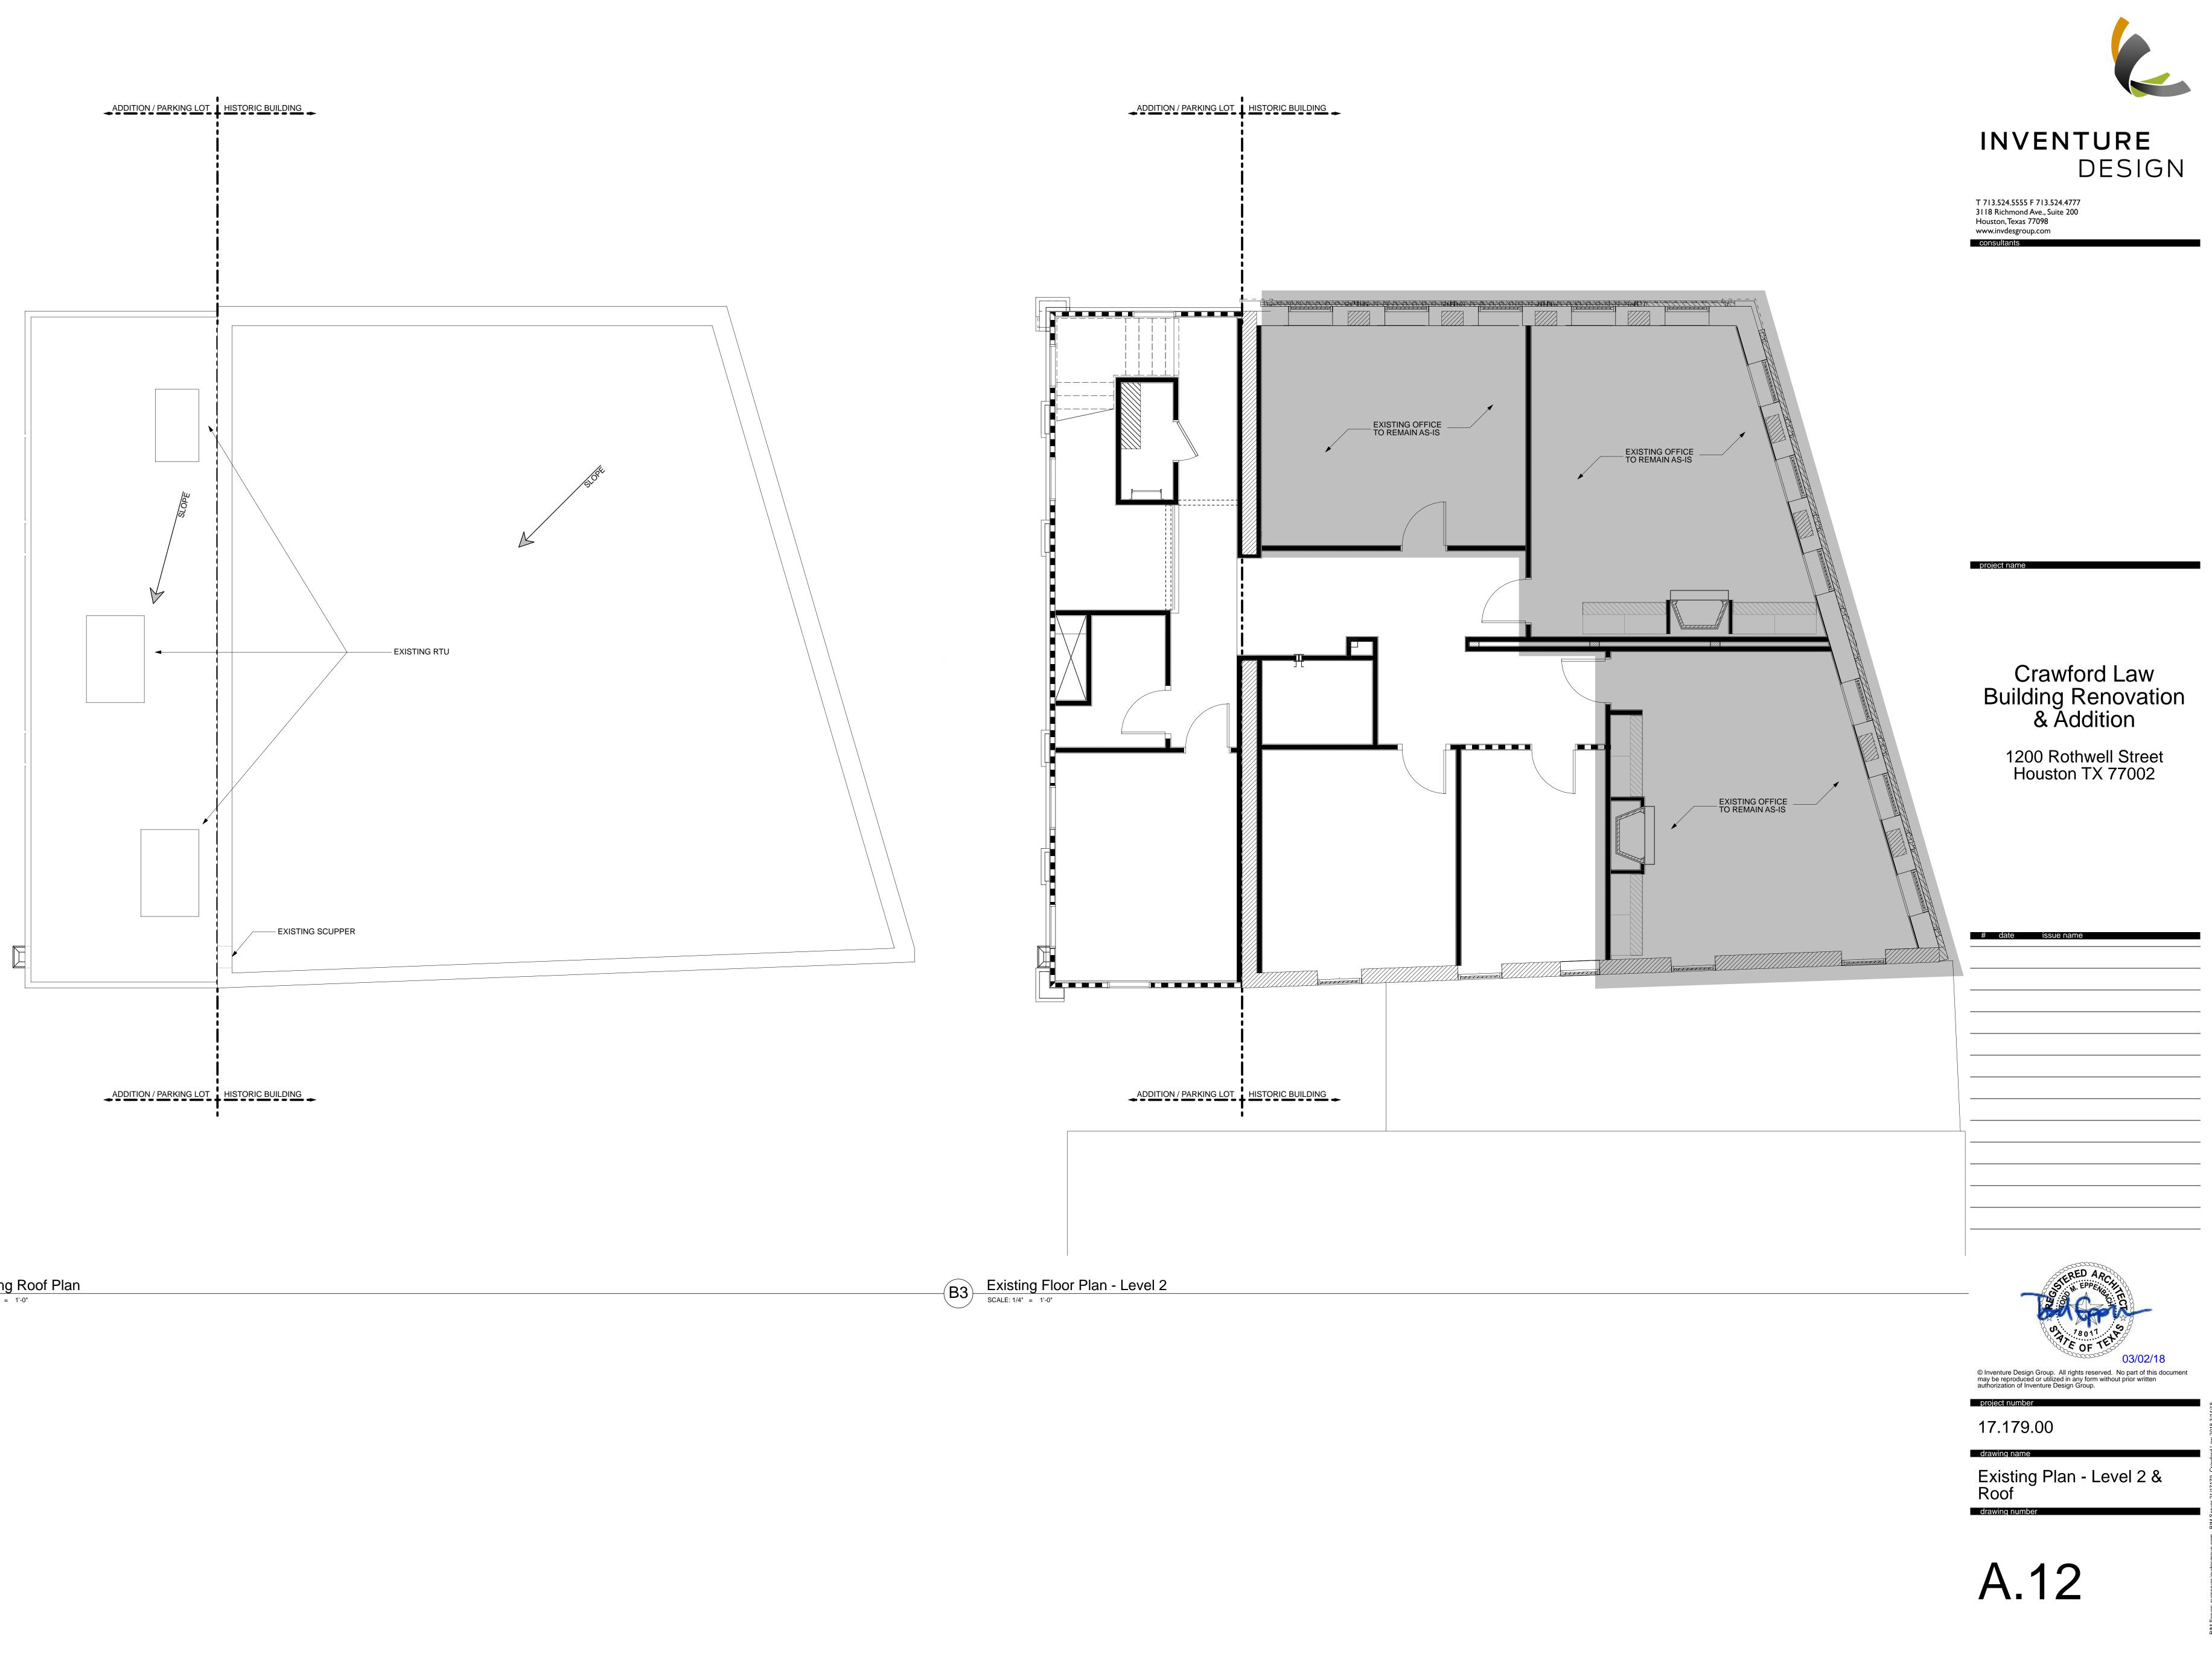





EXISTING ADDITIOI 80'-0"	N / PARKING	 /	HISTORIC 48'-0"
CALLED 0.0528 AC. C& R 2 PROPERTIES, L.P. H.C.C.F. NO. Y271901			
UNRESTRICTED RESERVE "A" STERRETT STREET SEC. 1 AMENDING PLAT NO 1 PARTIAL REPLAT NO 1 F.C. NO. 629151, H.C.M.R.			LLED 0.4571 AC. ECTS HOLDINGS, LLC F. NO. 20090518700






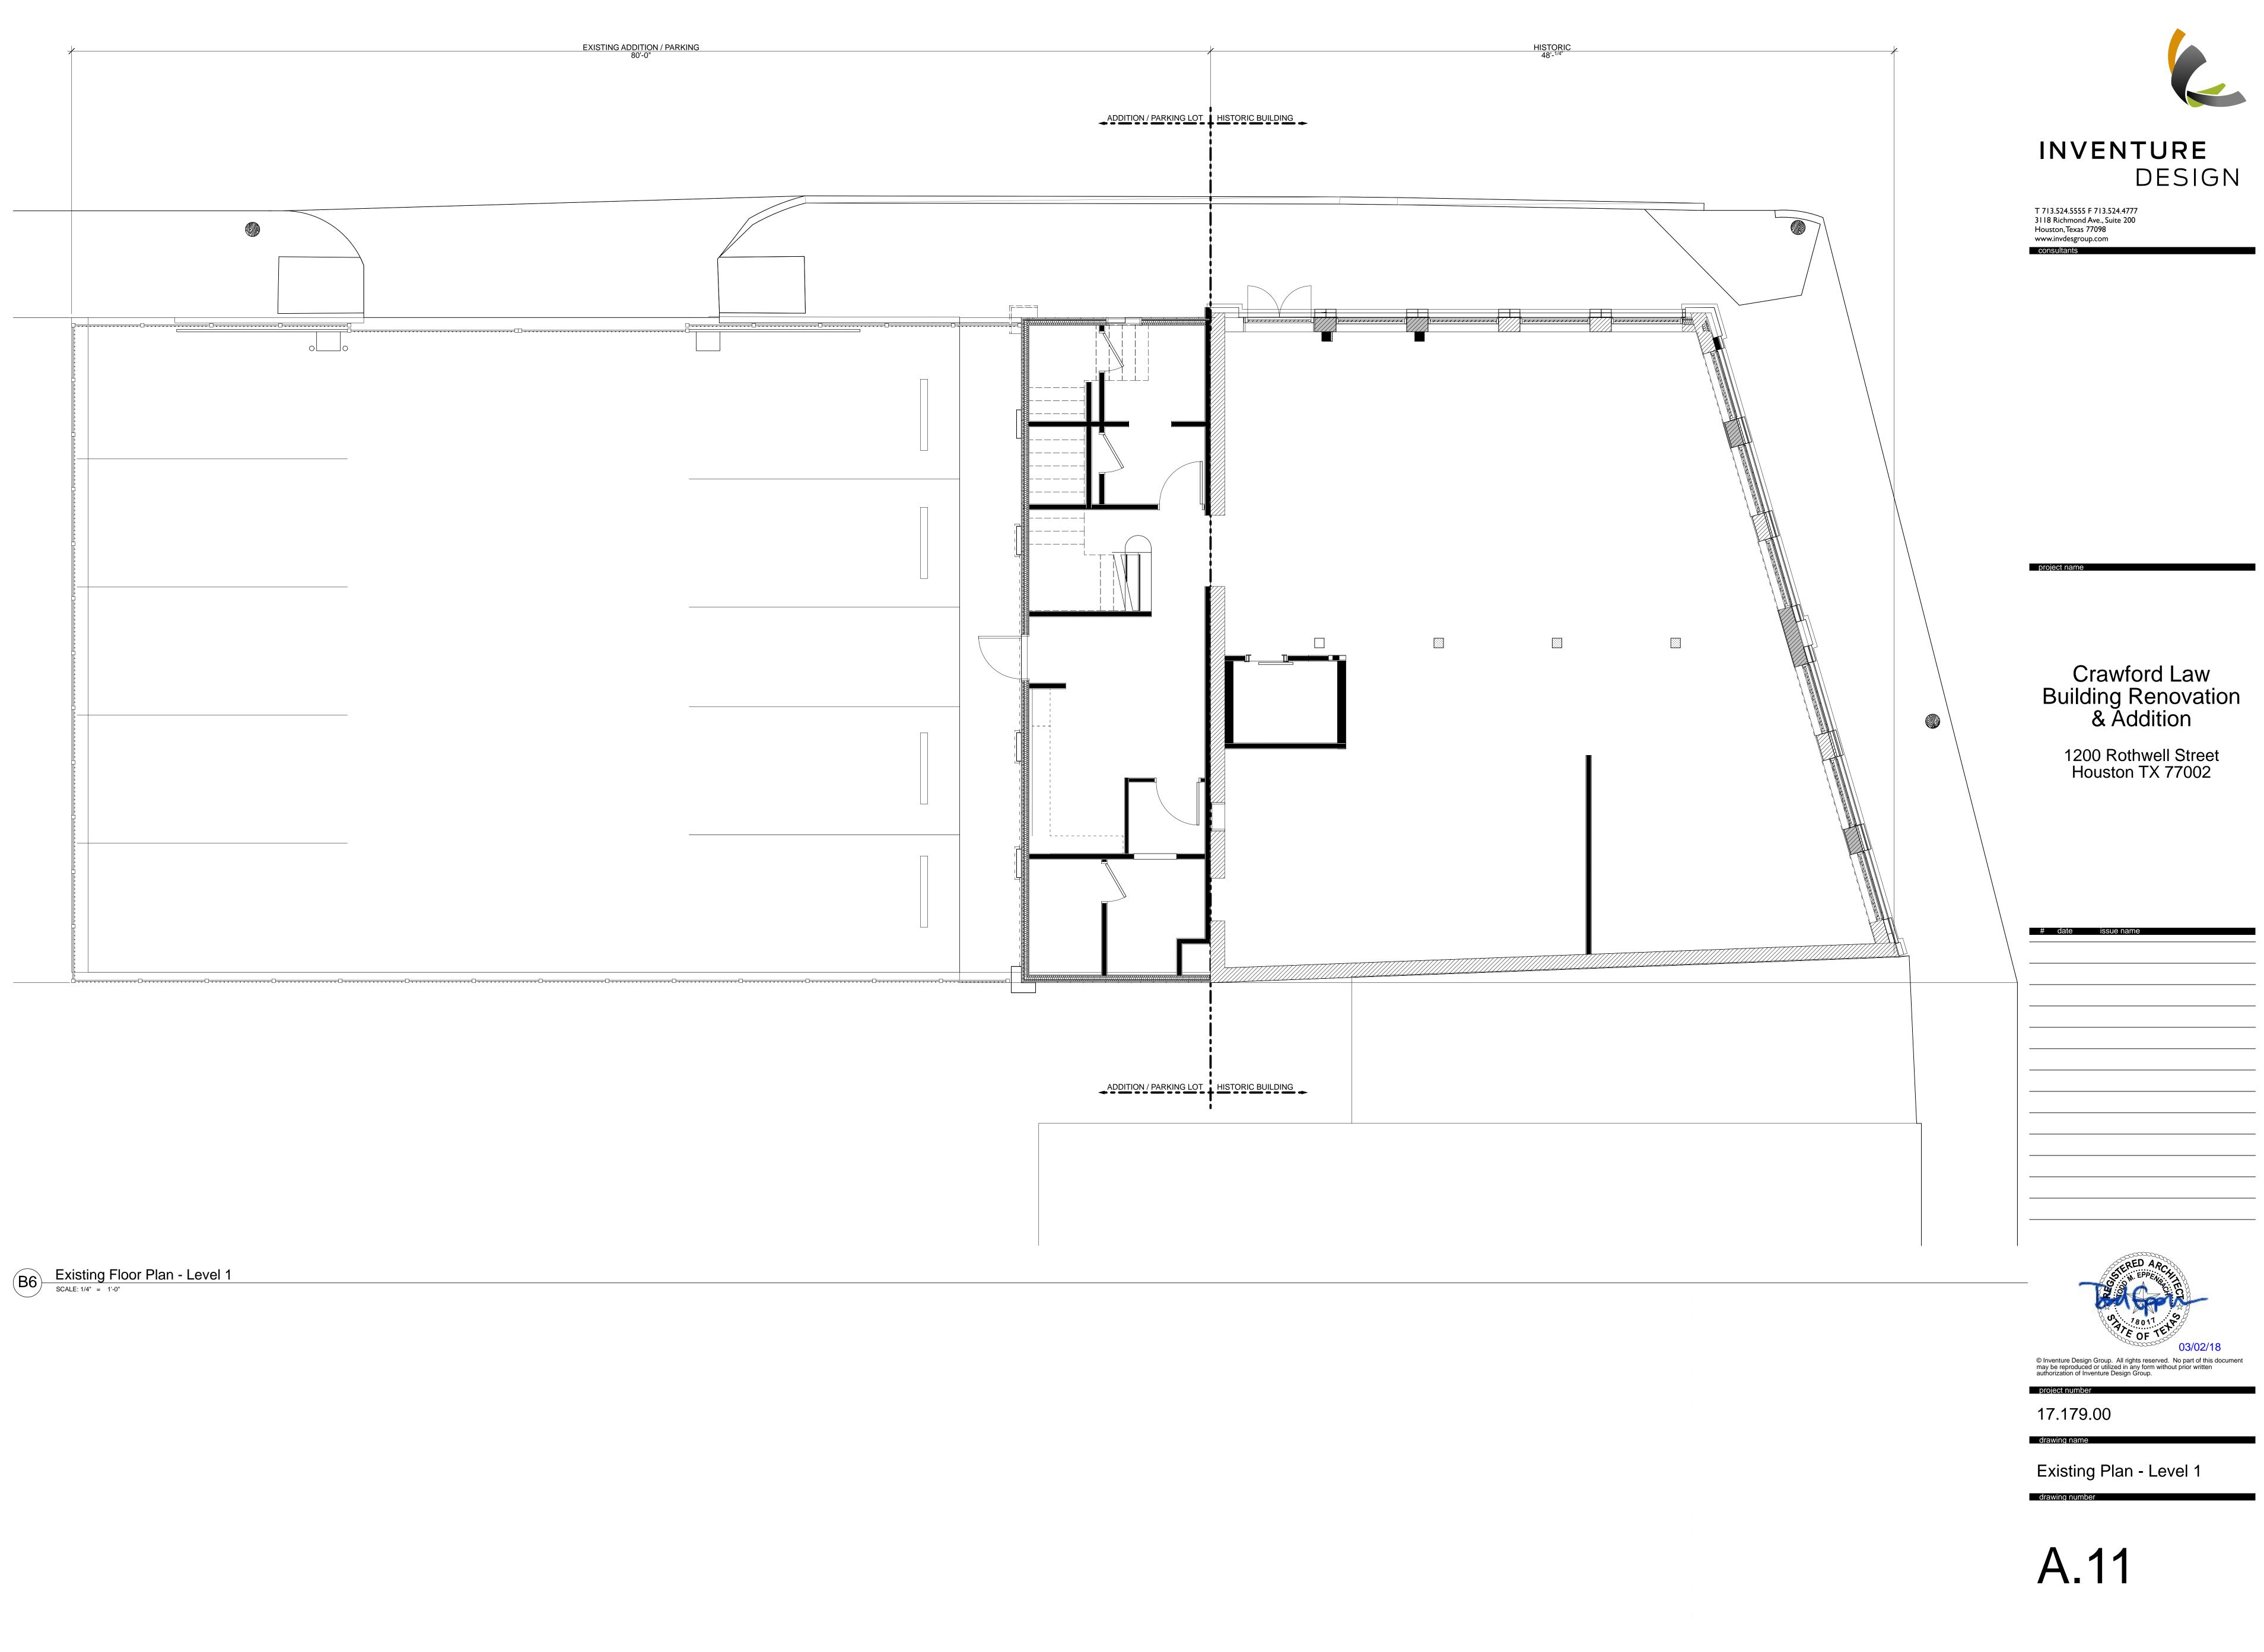

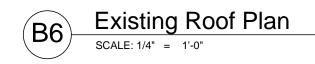



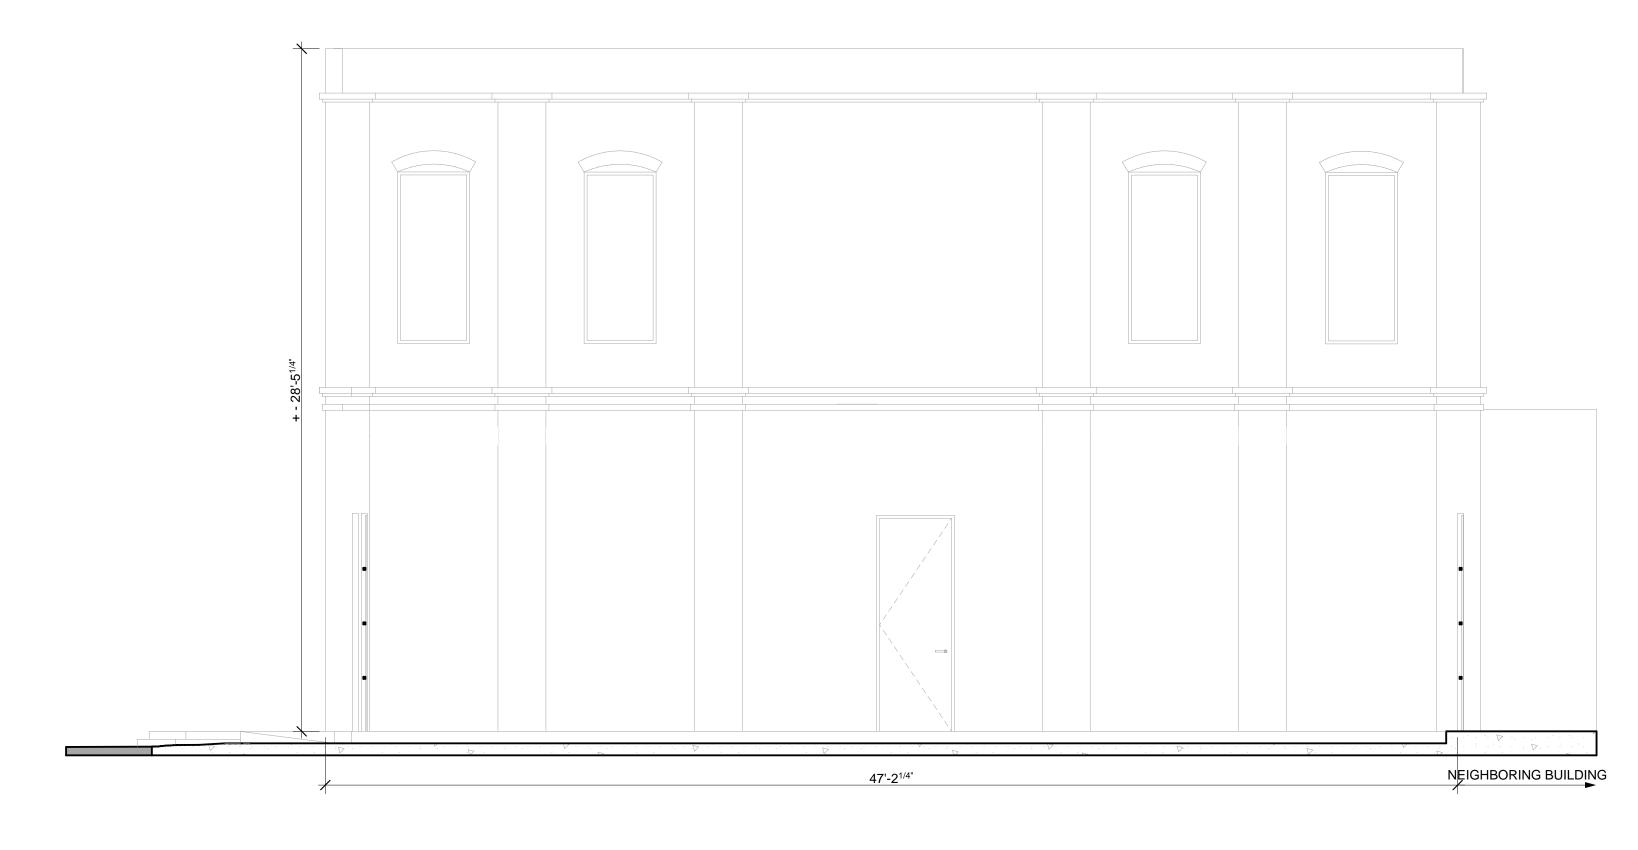



C3 Existing South Elevation SCALE: 1/4" = 1'-0"



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project number

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Existing Elevations

drawing number

A.13





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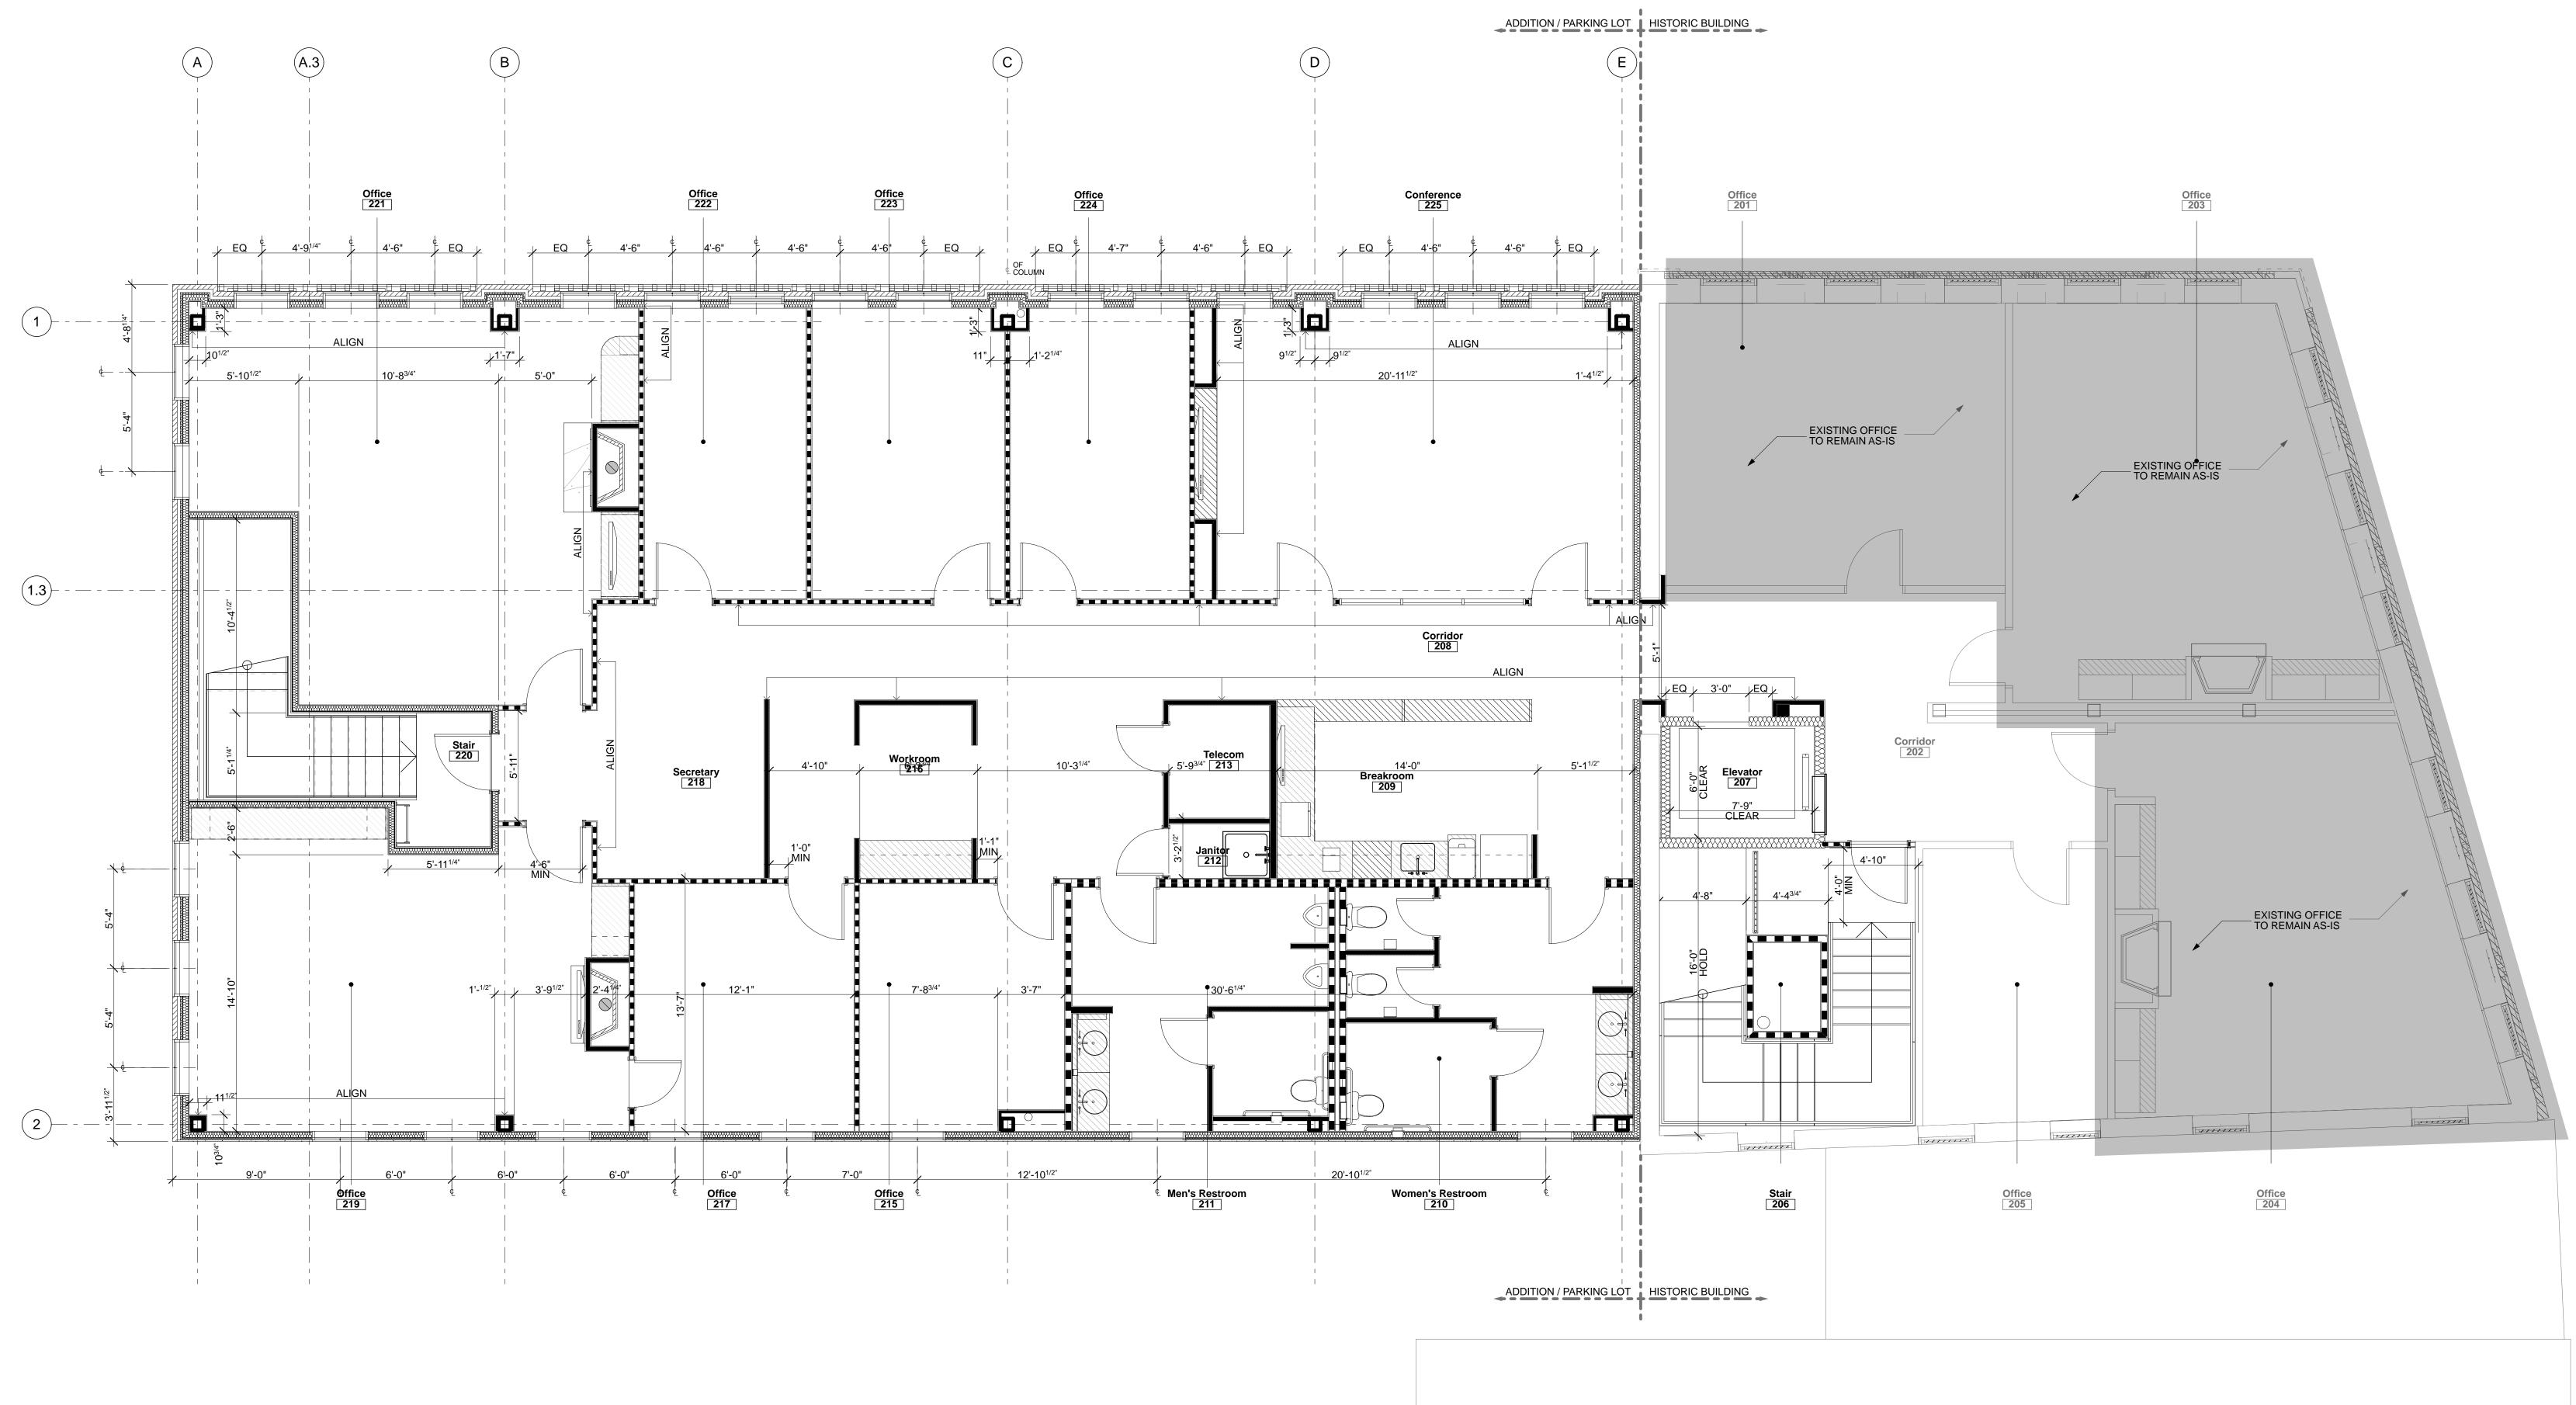
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project number 17.179.00

Existing Elevations

drawing number

A.14



B6 Dimensional Plan - Level 2
SCALE: 1/4" = 1'-0"
General Notes
A. GC TO FIELD VERIFY CONDITIONS BEFORE PRODCEEDING AND INFORM ARCHITECT AND TENANTS REPRESENTATIVE OF ANY DISCREPANCIES.
B. ALL DIMENSIONS ARE TO FACE OF GWB, EXCLUSIVE OF APPLIED FINISHES, TYPICAL, UNLESS NOTED OTHERWISE.
C. IN DIMENSION STRINGS, A "+/-" INDICATES A DIMENSION TO BE FIELD VERIFIED AFTER THE REMAINDER OF THE STRING IS LAID OUT. NOTIFY ARCHITECT OF ANY SIGNIFICANT DIMENSIONAL DISCREPANCIES GREATER THAN 1".
D. ALL WOOD BLOCKING SHALL BE FIRE RETARDANT TREATED TO CONFORM TO THE FIRE RESISTIVE STANDARDS OF THE LOCAL JURISDICATION HAVING AUTHORITY.
E. ALL FLOORS SHALL BE LEVELED TO 1/8" IN 10'0" OR TO INDUSTRY STANDARD. FLOORS SHALL BE FILLED AND SWEPT BROOM CLEAN.

F. GC TO VERIFY CONDITION OF EXISTING WINDOW TREATMENTS. REPLACED DAMAGED OR MISSING WITH NEW TO MATCH. ALL WINDOW TREATMENTS ARE TO BE CONSISTENT WITHIN EACH ROOM.




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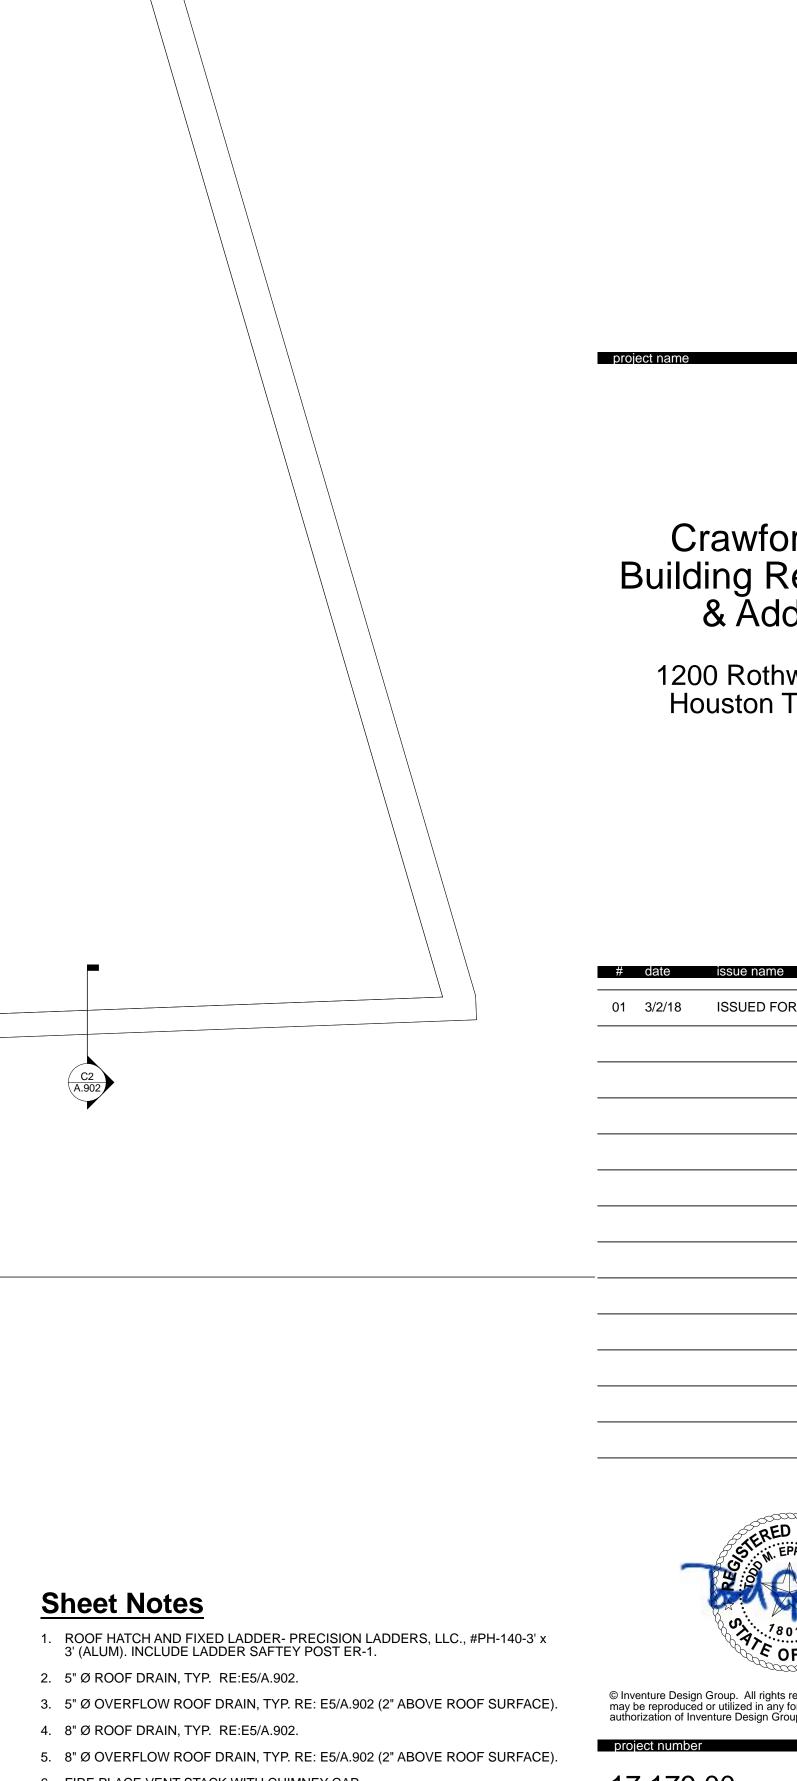
project name

date issue name







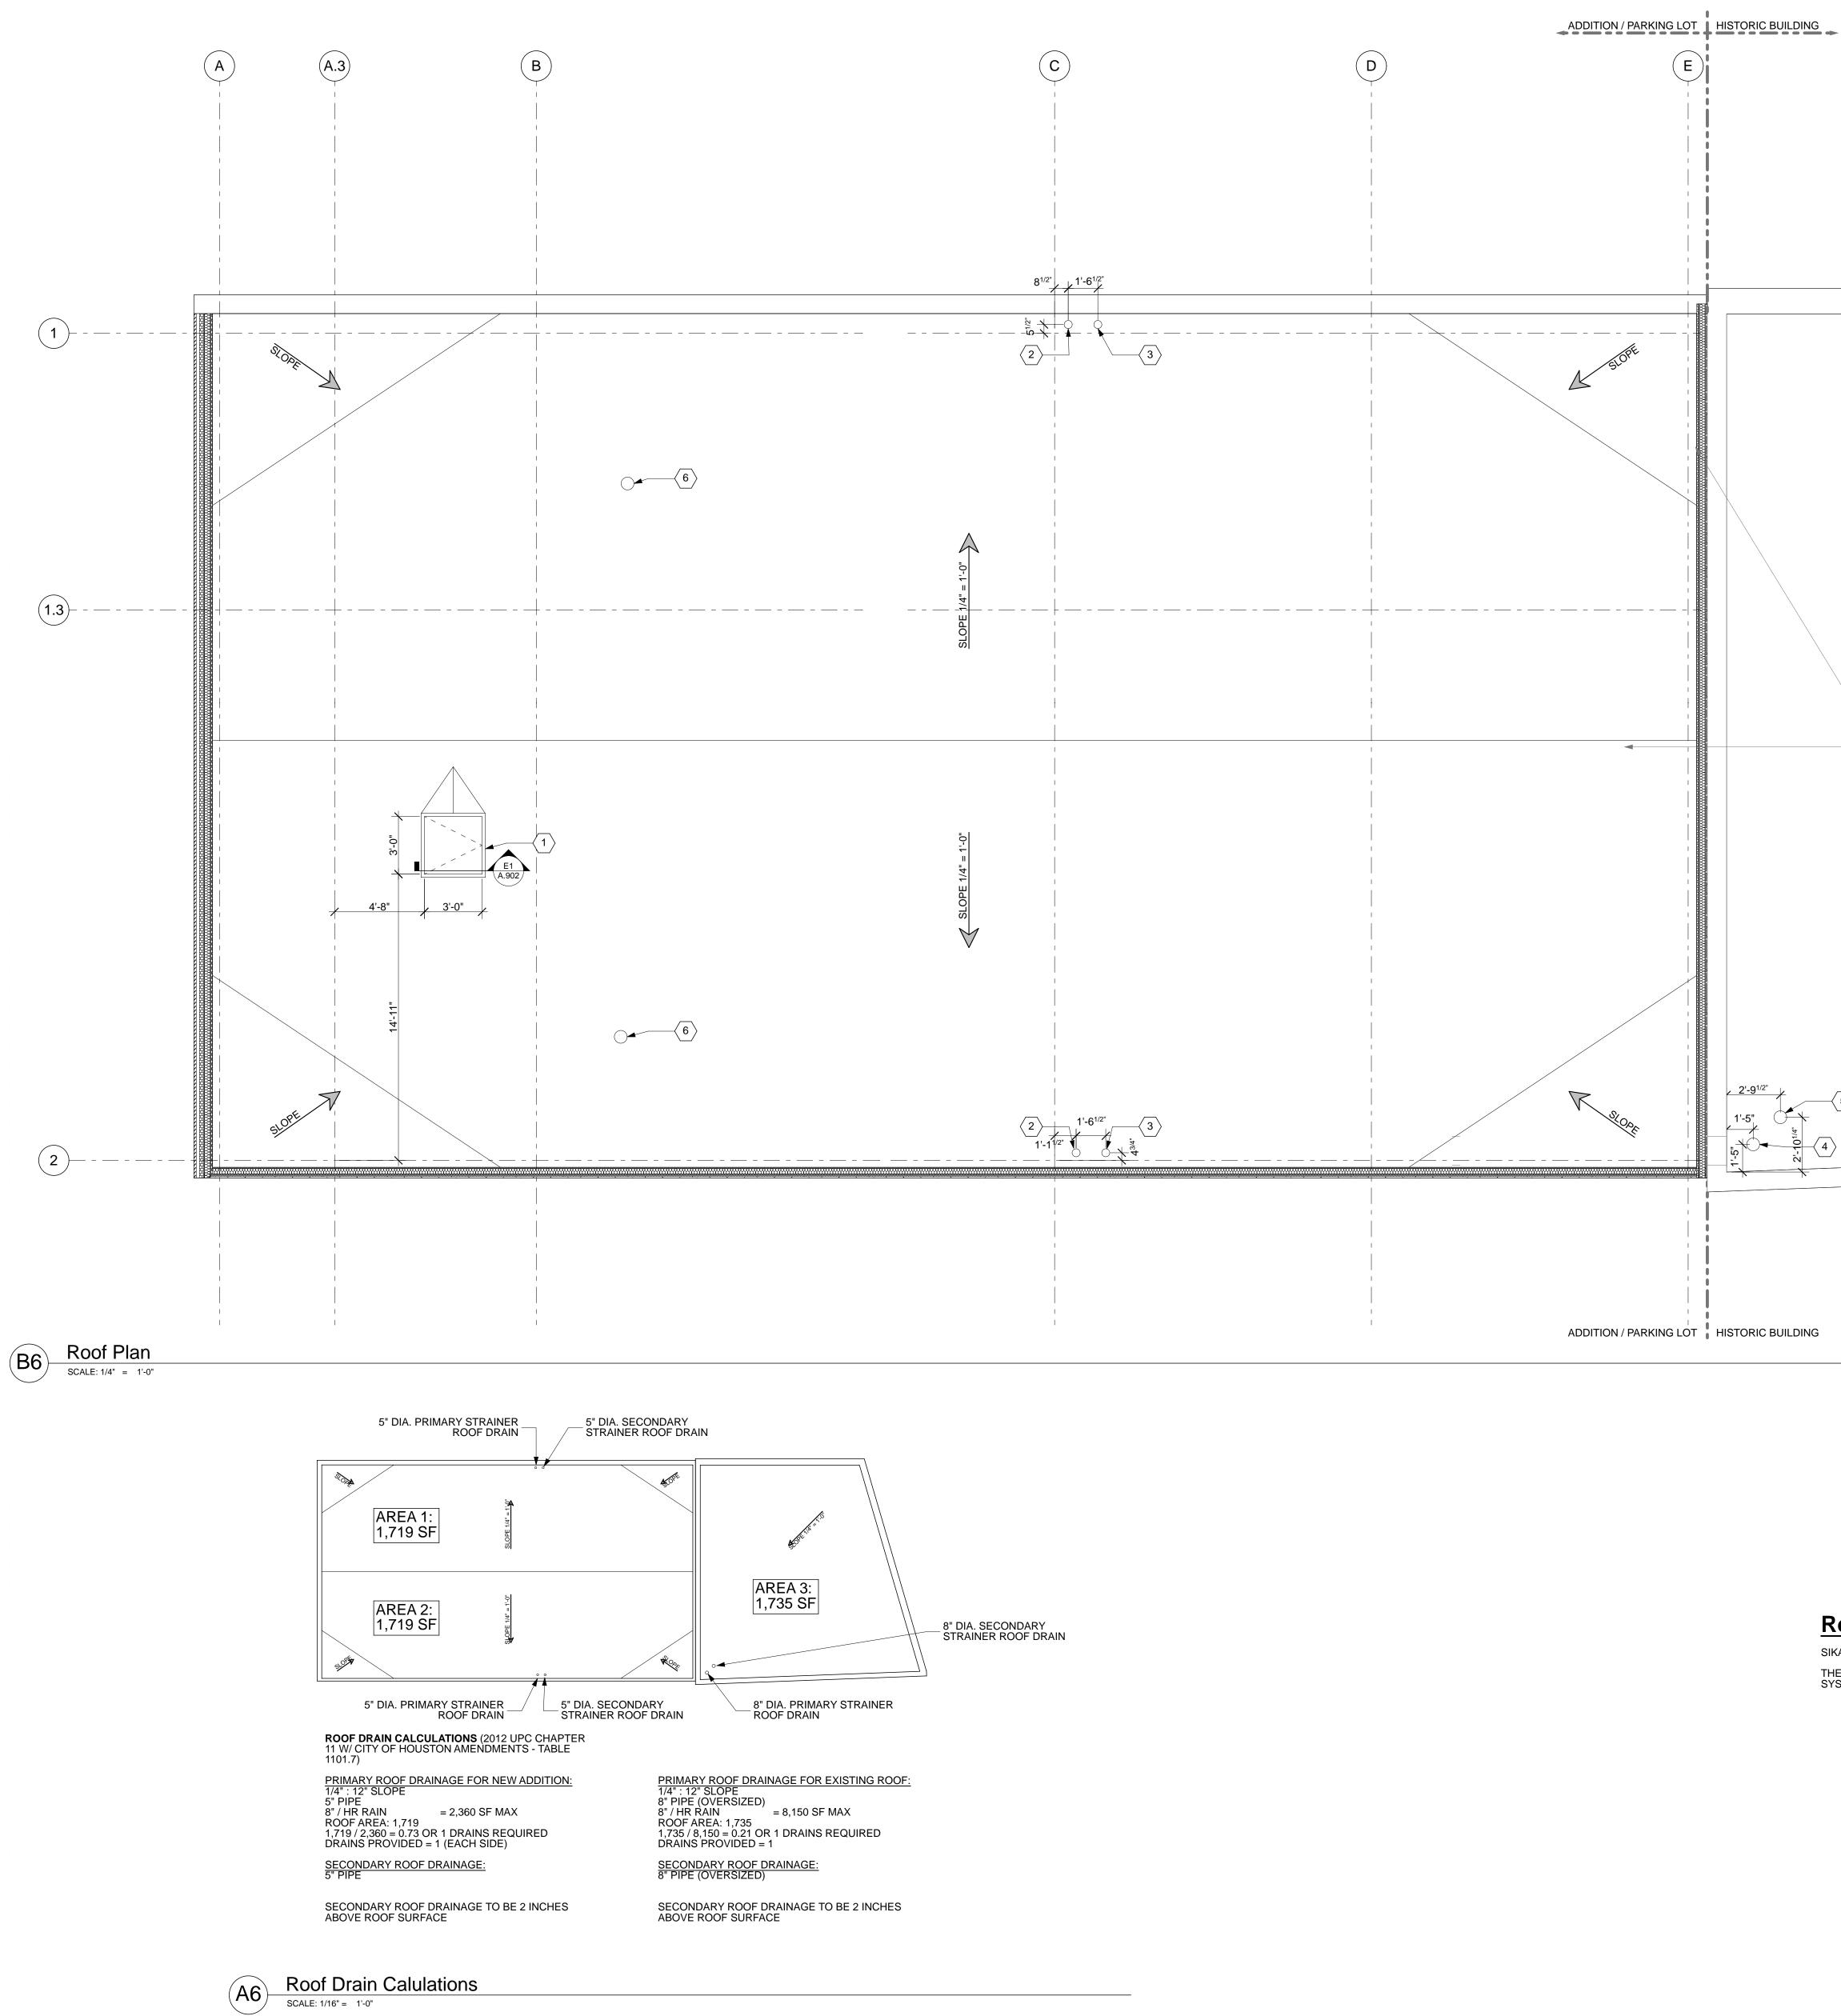

REMOVE EXISTING BUILT-UP ROOFING AT EXISTING BUILDING AND REPLACE WITH NEW THERMOPLASTIC MEMBRANE ROOF - SARNAFIL G410 FELTBACK ADHERED SYSTEM OVER TAPERED FOAM.

Roofing SIKA SARNAFIL- US

THERMOPLASTIC MEMBRANE ROOFING- SARNAFIL G410 FELTBACK ADHERED SYSTEM OVER TAPERED FOAM, REFER TO SPECIFICATIONS.

- 6. FIRE PLACE VENT STACK WITH CHIMNEY CAP



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