CERTIFICATE OF APPROPRIATENESS



APPLICATION FORM

	- Time ,					
PROPERTY						
Address 1027 Key Street, Houston Texas 77009						
Historic District / Landmark Norhill	HCAD# 062109000014					
Subdivision Norhill	Lot 14 Block 130					
DESIGNATION TYPE	PROPOSED ACTION					
☐ Landmark	Alteration or Addition Relocation					
Protected Landmark Noncontributing	Restoration					
☐ Archaeological Site ☐ Vacant	✓ New Construction ☐ Excavation					
DOCUMENTS						
Application checklist for each proposed action and all a	pplicable documentation listed within are attached					
OWNER	APPLICANT (if other than owner)					
Name Murray Thomas Flanagan	Name					
Company N/A	Company					
Mailing Address 1027 Key Street, Houston Texas 77009	Mailing Address					
Phone 832-549-6072	Phone					
Email	Email					
Signature January	Signature					
	Date					
Date JANUARY 5, 2015	Date					
ACKNOWLEDGEMENT OF RESPONSIBILITY						
and accurate description of existing and proposed conditi	able information requested on checklists to provide a complete ons. Preliminary review meeting or site visit with staff may be information and signature is required. Late or incomplete					
Deed Restrictions: You have verified that the work does n	ot violate applicable deed restrictions.					
departments, and employees, non-exclusive rights to repr Houston Archaeological and Historical Commission, the F commissions, agencies, and departments, on a City of	tions of the COA. Revisions to approved work require staff					
delays, fines or other penalties.	val. I aliale to comply with the OOA may result in project					

Planner: ____ Rev. 10.2014 Application received: ___/___ Application complete: ___/___/

CERTIFICATE OF APPROPRIATENESS





<u>Well in advance</u> of the COA application deadline contact staff to discuss your project and, if necessary, to make an appointment to meet with staff for a project consultation.

Complete all applicable sections and submit with the COA application form. Staff can assist you in determining what items are required for your scope of work. An incomplete application may cause delays in processing or may be deferred to the next agenda. Application materials must clearly represent current and proposed conditions. Refer to Houston Code of Ordinances, Ch. 33 VII, Sec. 33-242 for approval criteria for new construction in a historic district.

	
NEW BUILDING TYPE	DRAWINGS
 single-family residence multi-family residence commercial building mixed use building institutional building garage ✓ carport accessory structure other 	scale like drawings the same; include all dimensions and drawing scale; label with cardinal directions v site plan Page 5 floor plans Page 5 window and door schedule Page 3 & 4 v roof plan Page 6 elevations (all sides) Page 7 perspective
 WRITTEN DESCRIPTION ✓ describe new structure including square footage, levels, ✓ materials description; attach specification sheets if necess 	foundation, siding, windows, doors, roof and details Page 3 & 4, 8 - 15 Page 3 & 4, 8 - 15
PHOTOGRAPHS label photos with description and locati	on

site as seen from street, from front and corners, include neighboring properties Pages 16 - 18

PROPERTY ADDRESS:

Description of New Construction

Proposal for new construction of detached garage and carport at 1027 Key Street:

Pending HAHC review and approval, the current plan as detailed in the attached drawings and other requested materials is to construct a 1-story garage with an attached carport. Intending to preserve the historic character of Norhill (the neighborhood of residence), an attempt has been made to resemble the double gable architectural style of the residence. As proposed, the garage is to be a wood frame construction, providing approximately 335 ft2 of working space within the garage.

Structure:

- 1. Garage: Wood frame supplemented with engineered steel beams and columns to support North end of carport over garage door.
- 2. Carport: Wood frame supplemented with engineered steel beams and round steel columns at South end of carport.

Foundations:

- 3. Garage: slab-on-grade foundation
- 4. Carport columns (South end of Carport): engineered footings with a depth and diameter not less than indicated on City of Houston Drawing No. 08R05, "Post Foundation for Carports / Patios", attached.

Siding:

- 5. South and West side of garage:
 - a. Preference: Horizontal lap fiber cement board, wood grain pattern with $4 \frac{1}{2}$ " reveal to resemble look of residence. Reference attached Hardie catalog page.
 - b. If necessary: Horizontal lap board (real wood) with 4 ½" reveal.
- 6. North and East side of garage: An attempt will be made to reuse existing rub-board siding to the extent possible assuming enough material is available to complete one or both sides (existing garage is submitted for HAHC review for COA, for demolition).
- 7. Gable ends: Same as South and West sides described above in bullet 5 to match residence.

Windows:


- 8. Preference: Three (3) Double hung, Jeld Wen Premium vinyl or equivelent, intended for rough openings of 36" high x 34" wide. Reference attachment.
- 9. If necessary: Same style and size window constructed of wood.

Doors:

- 10. People entrance: One (1) Jeld Wen Craftsman Style, Smooth-Pro fiberglass glass panel or equivalent exterior door, 3'-0" x 6'—8". Reference attachment.
- 11. Garage door: Clopay Coachman Series One design or equivelent, steel-composite with glass windows, 10'-0" x 7'-0". Reference attachement.


Roof:

12. Composite shingle roof, color and style to match residence to extent possible.

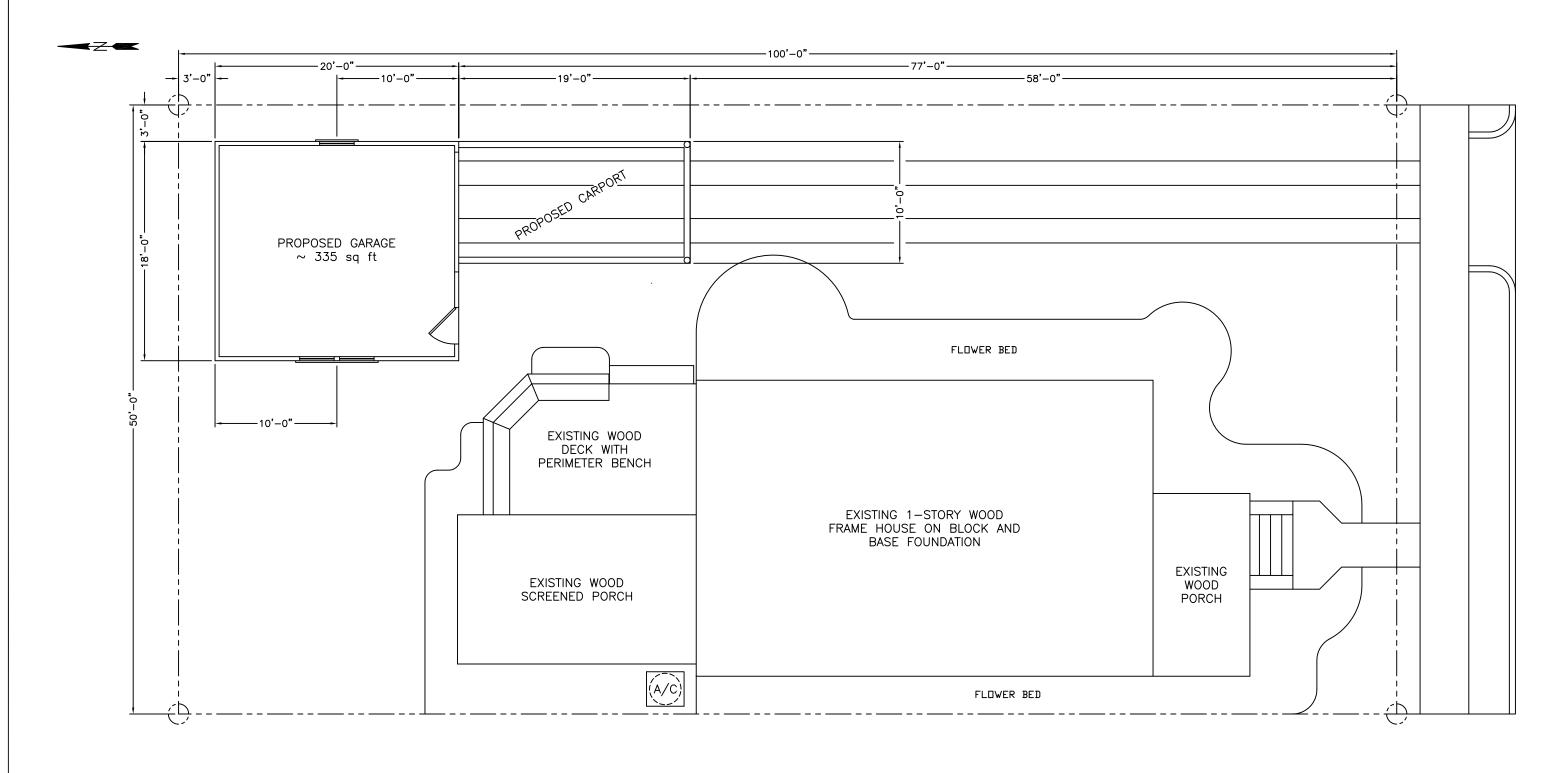


NOTES: 1. NO NOTES AT THIS POINT.


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10.		DESCRIPTION	DATE	DATE	DATE		DATE		
REVISIONS									
		•							
TITLE	TITLE: GARAGE/CARPORT ADDITION								
DRAW	ING:	SITE/FLOOR PLAN							
SERV	SERVICE NAME: —								
CLIENT/PROJECT: -									
LOCA	DCATION: 1027 KEY STREET								
PROJ	ECT:	-	DRAWING NO		s	HEET	REV.		
DRAW	N BY/DATE:	MTF / 1/2/15		A1 1,			С		

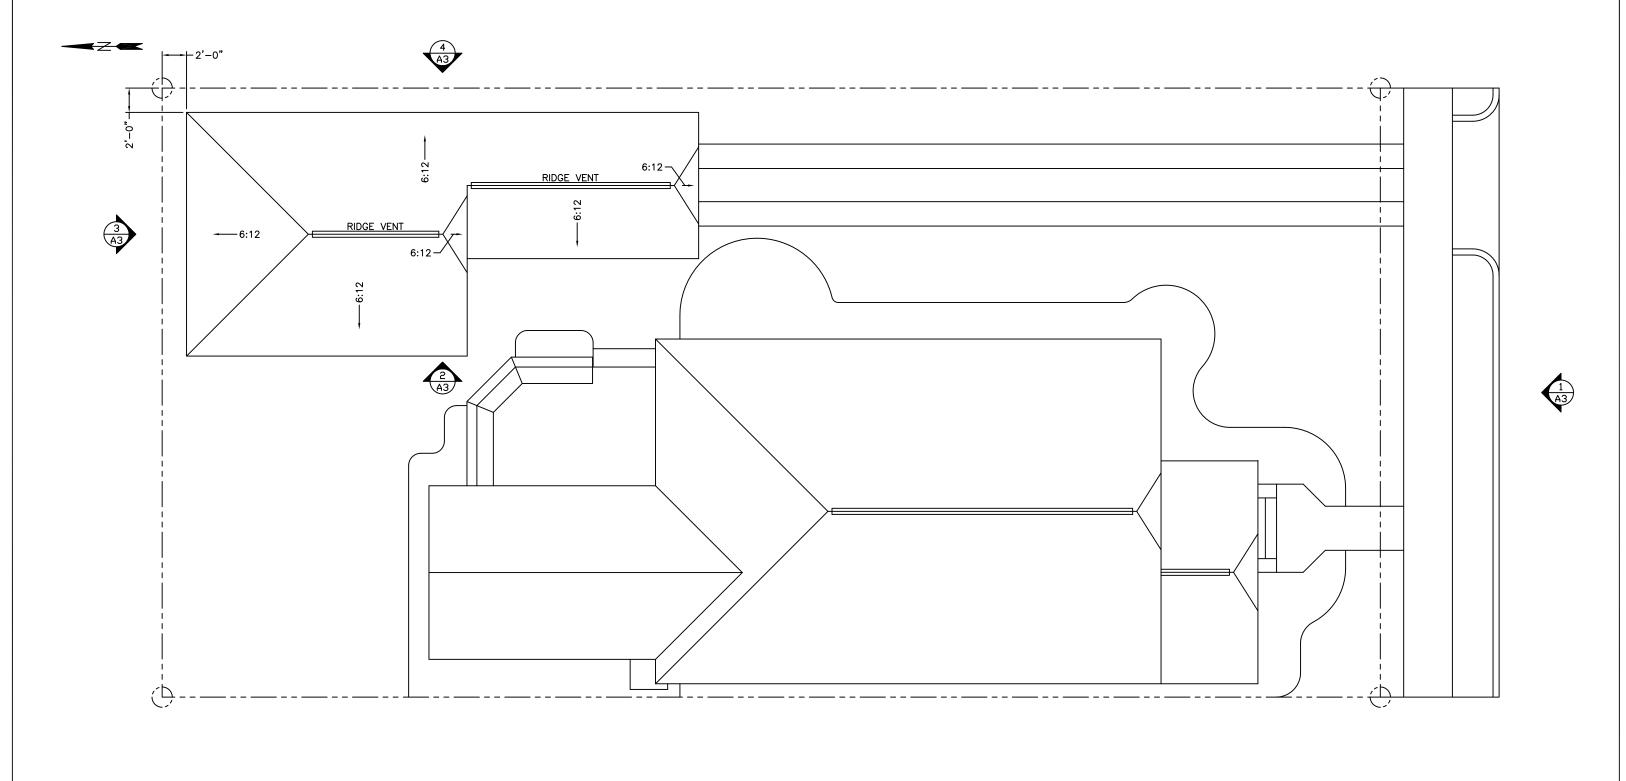



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REVISIONS										
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RAW	ING:	ROOF PLAN								
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LIEN	T/PROJECT:	ECT: —								
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VIEW 1 FRONT ELEVATION, NOTE 3

C ISSUE FOR APPROVAL 1/2/15 BY CHECKED APPROVED CLIENT DATE DATE DATE DATE DESCRIPTION REVISIONS TITLE: GARAGE/CARPORT ADDITION DRAWING: ELEVATIONS SERVICE NAME: CLIENT/PROJECT: 1027 KEY STREET LOCATION:

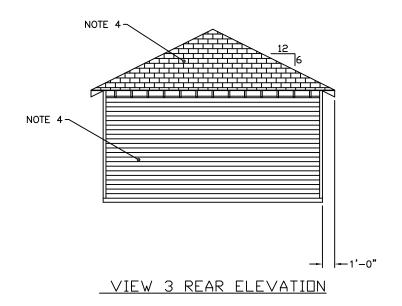PROJECT:

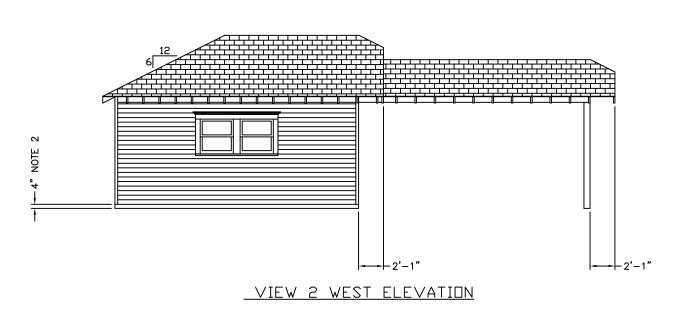
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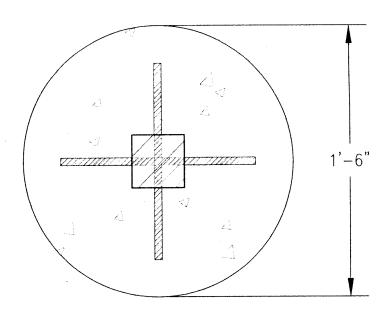
DRAWING NO.:

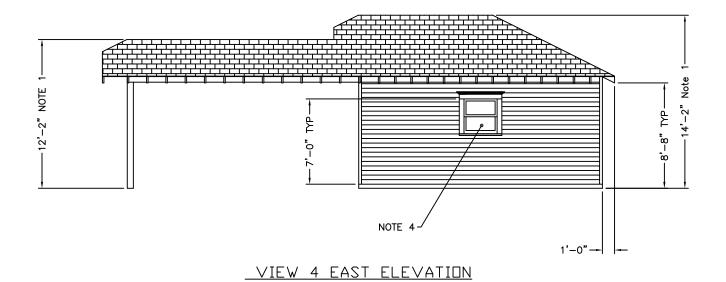SHEET REV.

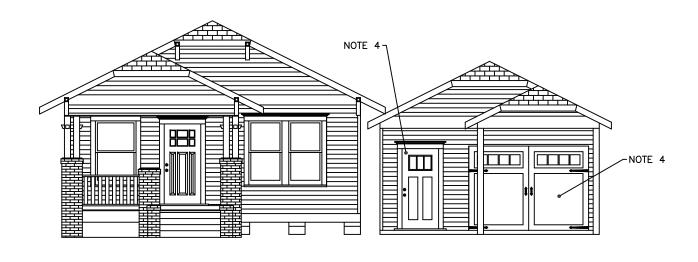- RIDGE HEIGHT MAY VARY A FEW INCHES PENDING FINAL SLAB FOUNDATION DESIGN ABOVE GRADE AND ATTIC JOIST DESIGN. CURRENT SLAB ELEVATION ABOVE GRADE IS DRAWIN IN AT 4". SLAB ELEVATION ABOVE GRADE PENDING FINAL DESIGN. EXISTING RESIDENCE INCLUDED FOR REFERENCE.

 REFERENCE WRITTEN DESCRIPTION FOR WINDOW AND DOOR SCHEDULE, SIDING AND ROOF DETAILS.



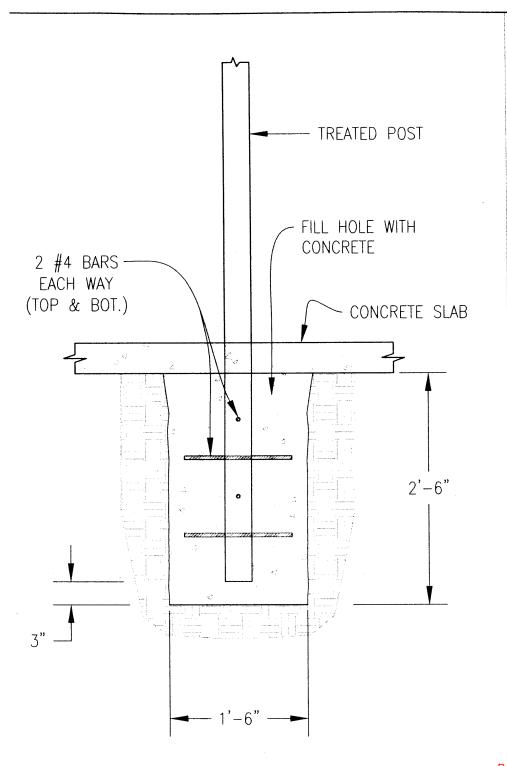

CROSS-SECTION

GENERAL NOTES:

- 1. USE TREATED #2 S.Y.P. DR EQUAL.
- 2. COMPRESSIVE STRENGTH OF CONCRETE = 2500 PSI.
- 3. ASSUMED SOIL BEARING CAPACITY = 1500 PSI.

CITY OF HOUSTON

Department of Public Works and Engineering

POST FOUNDATION FOR CARPORTS / PATIOS

APPROVED BY:

DATE: (/11/17/09

PHOYED BY:

CITY ENGINEER

Page 8 of 18

DWG No.: 08R05

1 of 1

HardiePlank® Lap Siding
HardiePanel® Vertical Siding

HardieShingle® Siding



SELECT CEDARMILL®*

Woodstock Brown

5/16 in. **Thickness** 12 ft. planks Length 9.25 in. 12 in. Width 5.25 in. 6.25 in. 7.25 in. 8.25 in. 10.75 in. 4 in. 5 in. 6 in. 7 in. 8 in. **Exposure ColorPlus Pcs./Pallet** 252 210 324 230 **Prime Pcs./Pallet** 360 252 152 16.7 9.3 20.0 14.3 Pcs./Sq. 25.0

Available Colors



Plank Coastal Colors*



View all HardiePlank Lap Siding Products

*6.25 in. and 8.25 in. also available in coastal colors. 9.25 in. and 12 in. only available primed.



Double-Hung Windows

Premium Vinyl

DOUBLE-HUNG									
UNIT SIZE ROUGH OPENING FRAME SIZE DAYLIGHT OPENING	17 1/2"(445) 18"(457) 17 1/2"(445) 10 1/4"(260)	19 1/2"(495) 20"(508) 19 1/2"(495) 12 1/4"(311)	21 1/2"(546) 22"(559) 21 1/2"(546) 14 1/4"(362)	23 1/2"(597) 24"(610) 23 1/2"(597) 16 1/4"(413)	25 1/2"(648) 26"(660) 25 1/2"(648) 18 1/4"(464)	27 1/2"(699) 28"(711) 27 1/2"(699) 20 1/4"(514)	29 1/2"(749) 30"(762) 29 1/2"(749) 22 1/4"(565)	30"(762) 32"(813)	
29 1/2"(749) 30"(762) 29 1/2"(749) 9 13/16"(249)[2]	VDH1830	VDH2030	VDH2230	VDH2430	VDH2630	VDH2830	VDH3030	VDH3230	VDH3430
35 1/2"(902) 36"(914) 35 1/2"(902) 12 13/16"(325)[2]	VDH1836	VDH2036	VDH2236	VDH2436	VDH2636	VDH2836	VDH3036	VDH3236	VDH3436
36 1/2"(927) 37"(940) 36 1/2"(927) 13 5/16"(338)[2]	VDH1837	VDH2037	VDH2237	VDH2437	VDH2637	VDH2837	VDH3037	VDH3237	VDH3437
37 1/2"(953) 38"(965) 37 1/2"(953) 13 13/16"(351)[2]	VDH1838	VDH2038	VDH2238	VDH2438	VDH2638	VDH2838	VDH3038	VDH3238	VDH3438
40 1/2"(1029) 41"(1041) 40 1/2"(1029) 15 5/16"(389)[2]	VDH1841	VDH2041	VDH2241	VDH2441	VDH2641	VDH2841	VDH3041	VDH3241	VDH3441
41 1/2"(1054) 42"(1067) 41 1/2"(1054) 15 13/16"(402)[2]	VDH1842	VDH2042	VDH2242	VDH2442	VDH2642	VDH2842	VDH3042	VDH3242	VDH3442
45 1/2"(1156) 46"(1168) 45 1/2"(1156) 17 13/16"(452)[2]	VDH1846	VDH2046	VDH2246	VDH2446	VDH2646	VDH2846	VDH3046	VDH3246	VDH3446
47 1/2"(1207) 48"(1219) 47 1/2"(1207) 18 13/16"(478)[2]	VDH1848	VDH2048	VDH2248	VDH2448	VDH2648	VDH2848	VDH3048	VDH3248	VDH3448

ELEVATION SYMBOL LEGEND:
VALUES IN () ARE IN MILLIMETER CONVERSIONS
VALUES IN [] ARE NUMBER OF DAYLIGHT OPENINGS PER UNIT

Note: Elevations shown DO NOT have exterior trim. Subtract 1/2"(12.7) from M.O.(Masonry Opening) for Unit Sizes. Masonry openings above include Sill Nose, see Trim Options page for Sill Nose specifications. For other Trim Options refer to the Unit Sizing, Rough Opening & Masonry Openings page. SCALE: 1/4" = 1'



Fiberglass Glass Panel Exterior Door

SMOOTH-PRO FIBERGLASS GLASS PANEL EXTERIOR DOOR



FEATURES

- Panel Options: smooth
- Finish Options: ready to paint or stain
- Glass Options: energy efficient, protective, privacy, direct glaze, decorative, grilles, blinds between the glass, venting door glass
- Maintenance Level: minimal
- Sizes: Typical sizes include 3'0" X 6'8" 3'0" X 8'0." For detailed available sizing please contact your Dealer.
- Project Type: new construction and replacement
- ENERGY STAR® Qualified Options: yes
- Warranty: limited lifetime

BACK TO TOP

Our customer service team is happy to assist you

CONTACT US



+ ADD TO MY PROJECT + PRINT

RELATED PRODUCTS







COACH/AN® collection

Clopay°

America's Favorite Garage Doors®

4-LAYER CONSTRUCTION



DACHMAN® collection

The Coachman® Collection gives your home classic elegance while complementing your home's architectural style. With four distinctive series, the Coachman Collection offers the sophisticated expression of a carriage house door with the science of durable steel and composite construction. It's the perfect blend of beauty and practicality-masterful in the details and innovative in design-and it's only from Clopay®.

4-Layer Construction



Warmer. Quieter. Stronger.

Coachman Collection® doors featuring Intellicore® insulation technology represent the ultimate smart choice for homeowners. Clopay's Intellicore is a proprietary polyurethane foam that is injected into a garage door, expanding to fill the entire structure. The result is a door with incredible strength and durability. Its dense insulation also produces a quieter door, while its industry-leading 18.4 R-value provides year-round comfort and improved energy efficiency. Smart, indeed.





INSULATION



CG MODELS 2"

POLYSTYRENE

INSULATION.




CD MODELS





Calculated door section R-value is in accordance with DASMA TDS-163.

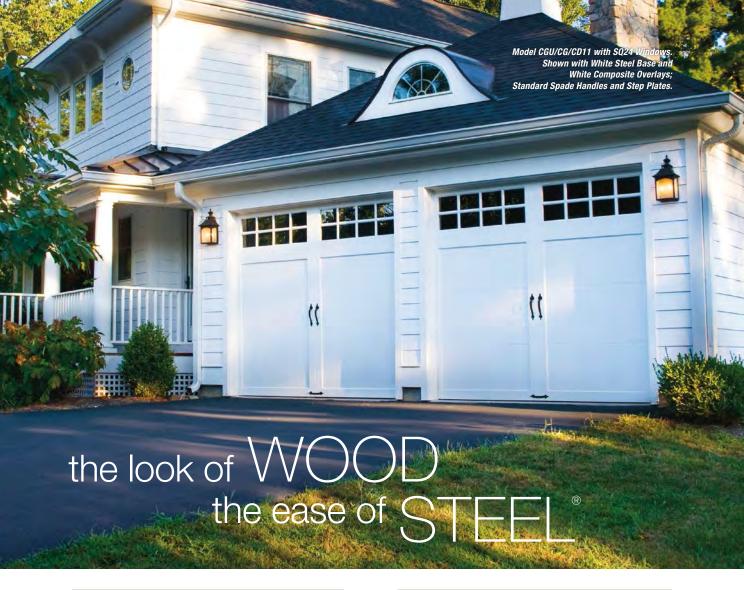

Colors

STEEL BASE DOOR COLORS



COMPOSITE OVERLAY COLORS




Due to the printing process, colors may vary.

- Composite overlays and steel base are available in White, Almond, Desert Tan and Sandtone. Overlay and steel base colors can be mixed to achieve desired look.
- Coachman® Collection doors can be painted using a high-quality exterior latex paint.

IMPORTANT: When painting your door, we require use of either a pre-approved paint or paints having an LRV (Light Reflective Value) of 38 or higher. Use of other paints will void the door's warranty.

A list of pre-approved paints can be found at http://info.garagedoors.com/lrv

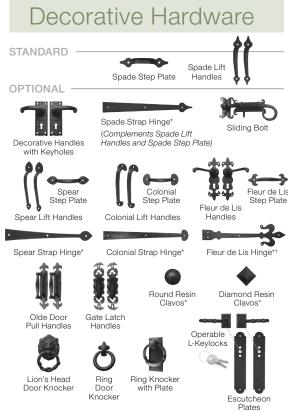


*Door may not open properly if installed near the top depending on opening dimensions and lift type. See your Clopay Dealer for more details.

†Hardware may not fit on all door designs. See your Clopay Dealer for more details.



SERIES ONE of the Coachman® Collection proves that in simplicity, there is sophistication. Architectural home designs such as Mission, Shaker, Country and Prairie look beautiful with the understated elegance of this classic look. Your choice of rectangular, square, arched windows or a solid top section provides that finishing touch.

SERIES ONE DESIGNS

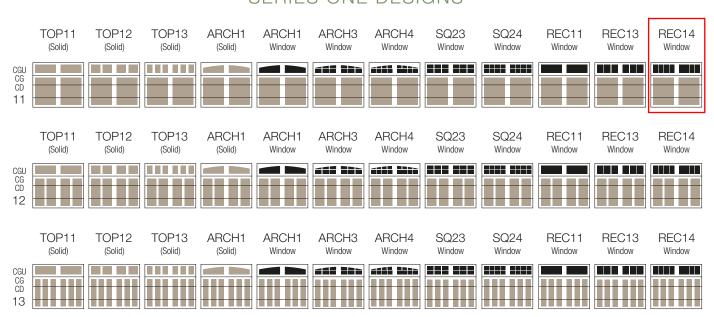

 $9'\ \textit{wide} \times \textit{7'}\ \textit{high}; \textit{shown with Sandtone base and White overlays. Consult your Clopay Dealer or clopay.com for additional sizes}$





